


TOWN OF TRUMBULL  
WINDOW REPLACEMENT AND ENTRANCES AT:  
**BOOTH HILL ELEMENTARY SCHOOL**  
544 BOOTH HILL ROAD  
TRUMBULL, CONNECTICUT 06484

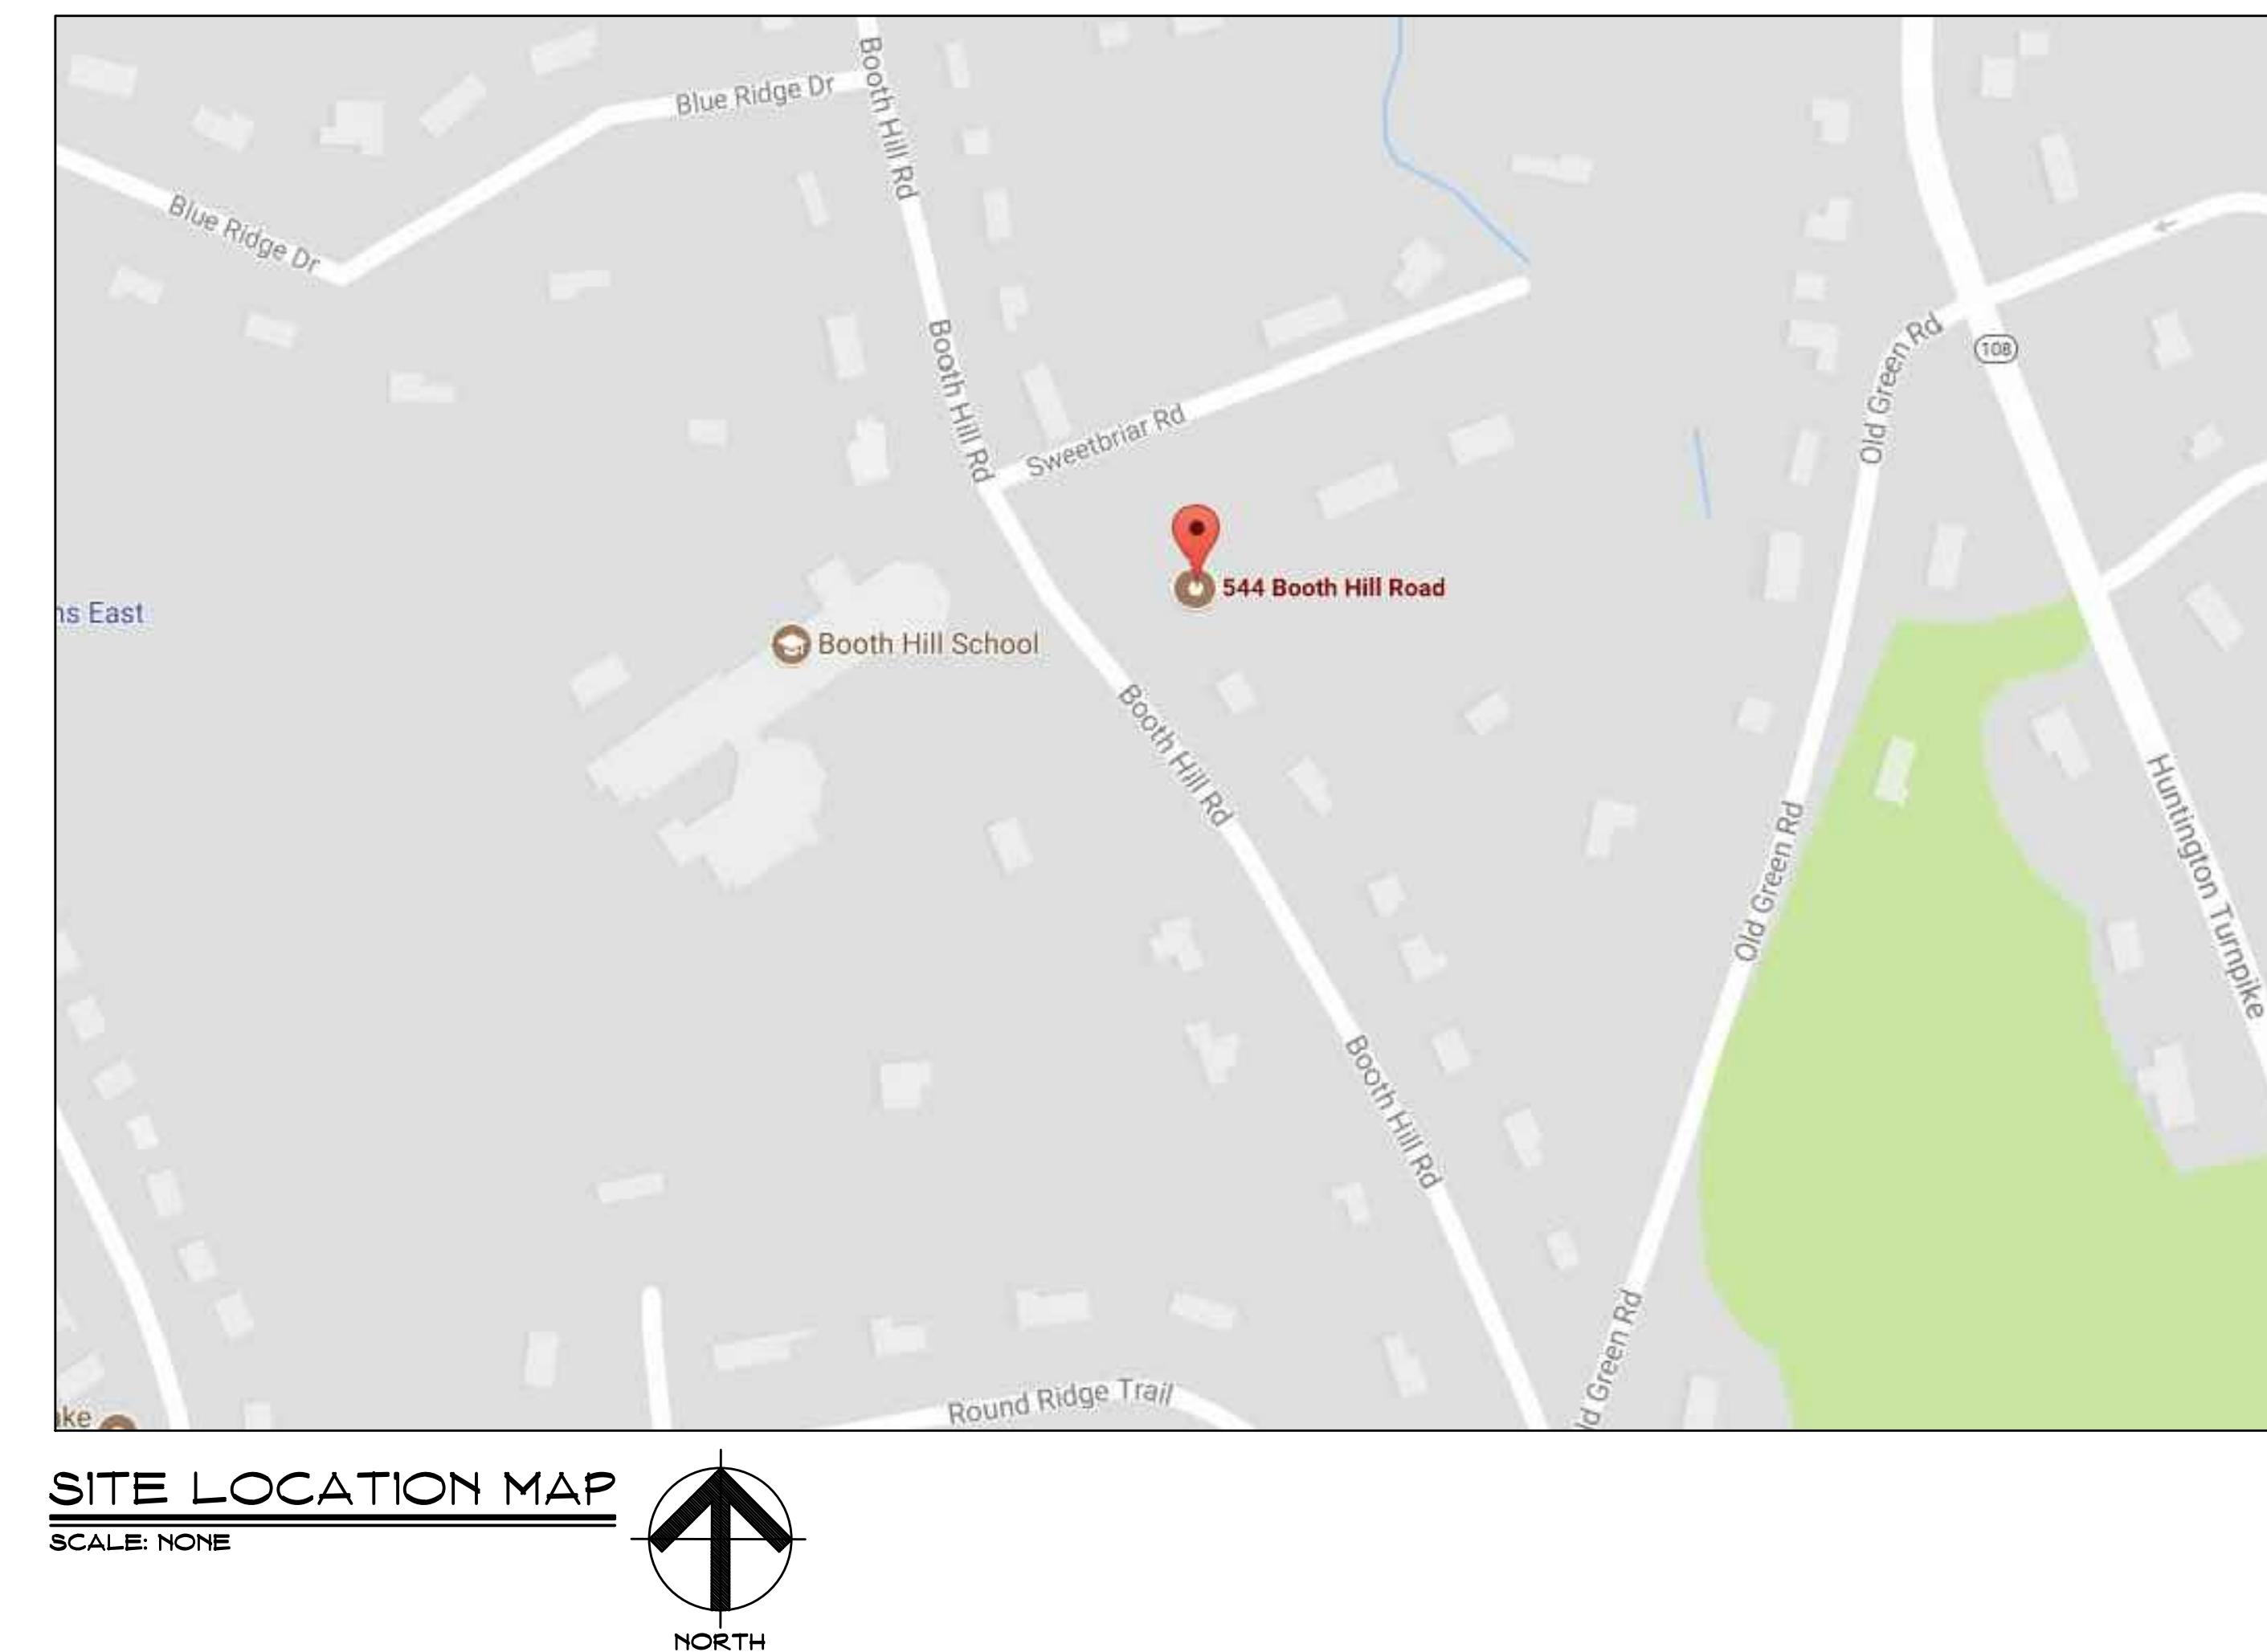

**DRAWING LIST:**

General:

Cover Sheet  
G1 General Information & Code Information

Architectural:

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A3	Floor Plans
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A6	Window Elevations
A7	Window Details
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A9	Schedules and Details
HM-01	Hazardous Materials Abatement Plans

SILVER / PETRUCELLI + ASSOCIATES

*Architects / Engineers / Interior Designers*

3190 Whitney Avenue, Hamden, CT 06518-2340

Tel. 203 230 9007 Fax. 203 230 8247

[silverpetrucelli.com](http://silverpetrucelli.com)




State Project Number: 144-0105 EC/CV

**MAY 24, 2018**  
Issued for Bid: July 12, 2018


<p><b>ARCHITECTURAL ABBREVIATIONS</b></p> <table border="0"> <tr><td>AB.</td><td>ANCHOR BOLT</td><td>R.</td><td>RISER</td></tr> <tr><td>A.C.P.</td><td>ASBESTOS CEMENT PIPE</td><td>R.A.D.</td><td>RADIUS</td></tr> <tr><td>ADJ.</td><td>ADJUSTABLE</td><td>R.C.P.</td><td>REINFORCED CONCRETE PIPE</td></tr> <tr><td>A.F.F.</td><td>ABOVE FINISH FLOOR</td><td>R.D.</td><td>ROOF DRAIN</td></tr> <tr><td>AC.</td><td>ACOUSTICAL CEILING TILE</td><td>REINF.</td><td>REINFORCEMENT</td></tr> <tr><td>ALLUM.</td><td>ALUMINUM</td><td>REQD.</td><td>REQUIRED</td></tr> <tr><td>APPROX.</td><td>APPROXIMATE</td><td>R.H.</td><td>ROOF HATCH</td></tr> <tr><td>ARCH.</td><td>ARCHITECTURAL</td><td>R.L.</td><td>ROOF LEADER</td></tr> <tr><td>ASPH.</td><td>ASPHALT</td><td>R.M.</td><td>ROOM</td></tr> <tr><td>AVG.</td><td>AVERAGE</td><td></td><td></td></tr> <tr><td>BSMT.</td><td>BASEMENT</td><td>S.</td><td>STORM</td></tr> <tr><td>BD.</td><td>BOARD</td><td>SAN.</td><td>SANITARY</td></tr> <tr><td>BRG.</td><td>BEARING</td><td>S.C.</td><td>SEALED CONCRETE</td></tr> <tr><td>BRK.</td><td>BRICK</td><td>SCHED.</td><td>SCHEDULE</td></tr> <tr><td>BIT.</td><td>BITUMINOUS</td><td>SECT.</td><td>SECTION</td></tr> <tr><td>BLK.</td><td>BLOCK</td><td>SIM.</td><td>SIMILAR</td></tr> <tr><td>BLDG.</td><td>BUILDING</td><td>S.O.G.</td><td>SLAB ON GRADE</td></tr> <tr><td>B.S.</td><td>BOTH SIDES</td><td>SPEC.</td><td>SPECIFICATIONS</td></tr> <tr><td>C.I.</td><td>CAST IRON</td><td>SQ. FT.</td><td>SQUARE FEET</td></tr> <tr><td>C.I.P.</td><td>CAST IN PLACE CONCRETE</td><td>STL.</td><td>STEEL</td></tr> <tr><td>CB.</td><td>CATCH BASIN</td><td>STRUCT.</td><td>STRUCTURAL</td></tr> <tr><td>C.B.R.</td><td>CATCH BASIN TO BE REMOVED</td><td>SUSP.</td><td>SUSPENDED SUSPENSION</td></tr> <tr><td>CL.</td><td>CENTER LINE</td><td>S.W.H.</td><td>SHEAR WALL</td></tr> <tr><td>C.B.D.</td><td>CHALK BOARD</td><td>S.W.F.</td><td>SHEAR WALL FOOTING</td></tr> <tr><td>C.C.</td><td>CURB CUT</td><td>T.</td><td>TELEPHONE</td></tr> <tr><td>COL.</td><td>CLEAR OUT</td><td>T.B.</td><td>TOP &amp; BOTTOM</td></tr> <tr><td>CONC.</td><td>CONCRETE</td><td>TECH.</td><td>TECHNOLOGY</td></tr> <tr><td>CONF.</td><td>CONFERENCE</td><td>T.O.</td><td>TOP OF</td></tr> <tr><td>CMU.</td><td>CONCRETE MASONRY UNIT</td><td>T.O.F.</td><td>TOP OF FRAME</td></tr> <tr><td>CONT.</td><td>CONTINUOUS/CONTINUE</td><td>T.O.S.</td><td>TOP OF SHELL</td></tr> <tr><td>C.J.</td><td>CONTROL/CONSTRUCTION JOINT</td><td>T/S.</td><td>TOP OF SLAB</td></tr> <tr><td>CONTR.</td><td>CONTRACTOR</td><td>T/W</td><td>TOP OF WALL</td></tr> <tr><td>DET.</td><td>DETAIL</td><td>T.T.F.</td><td>TRIM TO FIT</td></tr> <tr><td>DIA.</td><td>DIAMETER</td><td>TYP.</td><td>TYPICAL</td></tr> <tr><td>DIM.</td><td>DIMENSION</td><td>U.O.N.</td><td>UNLESS OTHERWISE NOTED</td></tr> <tr><td>DR.</td><td>DOOR</td><td>V.B.</td><td>VINYL BASE</td></tr> <tr><td>DN.</td><td>DOWN</td><td>V.C.T.</td><td>VINYL COMPOSITE TILE</td></tr> <tr><td>DWG.</td><td>DRAWING</td><td>VERT.</td><td>VERTICAL</td></tr> <tr><td>E.</td><td>ELECTRICAL</td><td>V.I.P.</td><td>VERTICAL IN FIELD</td></tr> <tr><td>EA.</td><td>EACH</td><td>W.</td><td>WATER</td></tr> <tr><td>E.C.T.R.</td><td>EXISTING CEILING TO REMAIN</td><td>WCJ.</td><td>WALL CONTROL JOINT</td></tr> <tr><td>ED.</td><td>EDUCATION</td><td>WD.</td><td>WOOD</td></tr> <tr><td>ELEC.</td><td>ELECTRICAL</td><td>WF.</td><td>WIDE FLANGE</td></tr> <tr><td>E.F.</td><td>EACH FACE</td><td>W.W.F.</td><td>WELDED WIRE FABRIC</td></tr> <tr><td>E.J.</td><td>EXPANSION JOINT</td><td>W.W.M.</td><td>WELDED WIRE MESH</td></tr> <tr><td>EL.</td><td>ELEVATION</td><td>•</td><td>AT</td></tr> <tr><td>ELEV.</td><td>ELEVATION</td><td>Φ</td><td>DIAMETER</td></tr> <tr><td>EMER.</td><td>EMERGENCY</td><td></td><td></td></tr> <tr><td>ENCL.</td><td>ENCLOSURE</td><td></td><td></td></tr> <tr><td>ENL.</td><td>ENLARGED</td><td></td><td></td></tr> <tr><td>ENT.</td><td>ENTRANCE</td><td></td><td></td></tr> <tr><td>EP.</td><td>EPoxy PAINT</td><td></td><td></td></tr> <tr><td>EQ.</td><td>EQUIPMENT</td><td></td><td></td></tr> <tr><td>ES.</td><td>EXPOSED STRUCTURE</td><td></td><td></td></tr> <tr><td>E.T.R.</td><td>EXISTING TO REMAIN</td><td></td><td></td></tr> <tr><td>E.W.</td><td>EACH WAY</td><td></td><td></td></tr> <tr><td>EW./E.F.</td><td>EACH WAY/EACH FACE</td><td></td><td></td></tr> <tr><td>EXAM.</td><td>EXAMINATION</td><td></td><td></td></tr> <tr><td>EXIST.</td><td>EXISTING</td><td></td><td></td></tr> <tr><td>EXP.</td><td>EXPANSION</td><td></td><td></td></tr> <tr><td>EXT.</td><td>EXTERIOR</td><td></td><td></td></tr> <tr><td>FDN.</td><td>FOUNDATION</td><td></td><td></td></tr> <tr><td>FF.</td><td>FINISHED FLOOR</td><td></td><td></td></tr> <tr><td>FP.</td><td>FOLDING PARTITION</td><td></td><td></td></tr> <tr><td>FIN.</td><td>FINISH, FINISHED</td><td></td><td></td></tr> <tr><td>FLAT.</td><td>FLAT</td><td></td><td></td></tr> <tr><td>FL.</td><td>FLOR</td><td></td><td></td></tr> <tr><td>FT.</td><td>FOOT</td><td></td><td></td></tr> <tr><td>F.S.</td><td>FAR SIDE</td><td></td><td></td></tr> <tr><td>FTG.</td><td>FOOTING</td><td></td><td></td></tr> <tr><td>G.</td><td>GAS</td><td></td><td></td></tr> <tr><td>GA.</td><td>GAGE, GAUGE</td><td></td><td></td></tr> <tr><td>GEN.</td><td>GENERAL</td><td></td><td></td></tr> <tr><td>G.C.</td><td>GENERAL CONTRACTOR</td><td></td><td></td></tr> <tr><td>GYP.</td><td>GYPSUM</td><td></td><td></td></tr> <tr><td>GYP. BD.</td><td>GYPSUM BOARD</td><td></td><td></td></tr> <tr><td>H.C.</td><td>HANDICAPPED</td><td></td><td></td></tr> <tr><td>HD.</td><td>HEADERS</td><td></td><td></td></tr> <tr><td>HDWR.</td><td>HARDWARE</td><td></td><td></td></tr> <tr><td>HGT.</td><td>HEIGHT</td><td></td><td></td></tr> <tr><td>HP.</td><td>HIGH POINT</td><td></td><td></td></tr> <tr><td>HM.</td><td>HOLLOW METAL</td><td></td><td></td></tr> <tr><td>HRIZ.</td><td>HORIZONTAL, HORIZONTALLY</td><td></td><td></td></tr> <tr><td>HS.</td><td>HOSE BIBB</td><td></td><td></td></tr> <tr><td>HR.</td><td>HOUR</td><td></td><td></td></tr> <tr><td>HYD.</td><td>HYDRANT</td><td></td><td></td></tr> <tr><td>INSUL.</td><td>INSULATION, INSULATED</td><td></td><td></td></tr> <tr><td>INT.</td><td>INTERIOR</td><td></td><td></td></tr> <tr><td>IV.</td><td>INVERT</td><td></td><td></td></tr> <tr><td>JAN.</td><td>JANITOR</td><td></td><td></td></tr> <tr><td>K.P.</td><td>KICK PLATE</td><td></td><td></td></tr> <tr><td>LAM.</td><td>LAMINATE</td><td></td><td></td></tr> <tr><td>LF.</td><td>LINEAL FOOT</td><td></td><td></td></tr> <tr><td>LG.</td><td>LONG</td><td></td><td></td></tr> <tr><td>LOC.</td><td>LOCATION</td><td></td><td></td></tr> <tr><td>LP.</td><td>LOW POINT</td><td></td><td></td></tr> <tr><td>LTG.</td><td>LIGHTING</td><td></td><td></td></tr> <tr><td>M.</td><td>MINUTE</td><td></td><td></td></tr> <tr><td>M.A.S.</td><td>MATERIAL</td><td></td><td></td></tr> <tr><td>MAX.</td><td>MAXIMUM</td><td></td><td></td></tr> <tr><td>MECH.</td><td>MECHANICAL</td><td></td><td></td></tr> <tr><td>M.H.</td><td>MANHOLE</td><td></td><td></td></tr> <tr><td>MIN.</td><td>MINIMUM</td><td></td><td></td></tr> <tr><td>MIS.</td><td>MISCELLANEOUS</td><td></td><td></td></tr> <tr><td>M.O.</td><td>MASONRY OPENING</td><td></td><td></td></tr> <tr><td>MTD.</td><td>MOUNTED</td><td></td><td></td></tr> <tr><td>NA.</td><td>NOT APPLICABLE</td><td></td><td></td></tr> <tr><td>N.C.</td><td>NOT IN CONTRACT</td><td></td><td></td></tr> <tr><td>NO.</td><td>NUMBER</td><td></td><td></td></tr> <tr><td>NOM.</td><td>NOMINAL</td><td></td><td></td></tr> <tr><td>N.P.S.</td><td>NOMINAL PIPE SIZE</td><td></td><td></td></tr> <tr><td>N.S.</td><td>NEAR SIDE</td><td></td><td></td></tr> <tr><td>N.T.S.</td><td>NOT TO SCALE</td><td></td><td></td></tr> <tr><td>O.C.</td><td>ON CENTER</td><td></td><td></td></tr> <tr><td>O.C.C.</td><td>OCUPANT</td><td></td><td></td></tr> <tr><td>O.D.</td><td>CUTTING DIAMETER</td><td></td><td></td></tr> <tr><td>OPNG.</td><td>OPENING</td><td></td><td></td></tr> <tr><td>P.C.B.</td><td>PAINTED CONCRETE BLOCK</td><td></td><td></td></tr> <tr><td>P.G.B.</td><td>PAINTED GYPSUM BOARD</td><td></td><td></td></tr> <tr><td>PL.</td><td>PLATE</td><td></td><td></td></tr> <tr><td>PLUMB.</td><td>PLUMBING</td><td></td><td></td></tr> <tr><td>PLYWD.</td><td>PLYWOOD</td><td></td><td></td></tr> <tr><td>PREP.</td><td>PREPARATION</td><td></td><td></td></tr> <tr><td>P.T.</td><td>PRESURE TREATED</td><td></td><td></td></tr> <tr><td>P.T.D.</td><td>PAINTER</td><td></td><td></td></tr> <tr><td>P.V.C.</td><td>POLYVINYLL CHLORIDE</td><td></td><td></td></tr> </table>			AB.	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FINISH, FINISHED			FLAT.	FLAT			FL.	FLOR			FT.	FOOT			F.S.	FAR SIDE			FTG.	FOOTING			G.	GAS			GA.	GAGE, GAUGE			GEN.	GENERAL			G.C.	GENERAL CONTRACTOR			GYP.	GYPSUM			GYP. BD.	GYPSUM BOARD			H.C.	HANDICAPPED			HD.	HEADERS			HDWR.	HARDWARE			HGT.	HEIGHT			HP.	HIGH POINT			HM.	HOLLOW METAL			HRIZ.	HORIZONTAL, HORIZONTALLY			HS.	HOSE BIBB			HR.	HOUR			HYD.	HYDRANT			INSUL.	INSULATION, INSULATED			INT.	INTERIOR			IV.	INVERT			JAN.	JANITOR			K.P.	KICK PLATE			LAM.	LAMINATE			LF.	LINEAL FOOT			LG.	LONG			LOC.	LOCATION			LP.	LOW POINT			LTG.	LIGHTING			M.	MINUTE			M.A.S.	MATERIAL			MAX.	MAXIMUM			MECH.	MECHANICAL			M.H.	MANHOLE			MIN.	MINIMUM			MIS.	MISCELLANEOUS			M.O.	MASONRY OPENING			MTD.	MOUNTED			NA.	NOT APPLICABLE			N.C.	NOT IN CONTRACT			NO.	NUMBER			NOM.	NOMINAL			N.P.S.	NOMINAL PIPE SIZE			N.S.	NEAR SIDE			N.T.S.	NOT TO SCALE			O.C.	ON CENTER			O.C.C.	OCUPANT			O.D.	CUTTING DIAMETER			OPNG.	OPENING			P.C.B.	PAINTED CONCRETE BLOCK			P.G.B.	PAINTED GYPSUM BOARD			PL.	PLATE			PLUMB.	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14. CODES TO WHICH THIS PROJECT WAS DESIGNED	2012 IBC/2016 CT State Building Code w/Supplement _____ 2016 CT State Building Code w/Supplement _____ 2005 CSC State Fire Code w/Supplement _____ 2009 AMEND. 2005 CT State Fire Code w/Supplement _____ MOST CURRENT State Health Code _____ MOST CURRENT OSHA _____ - Section 504 _____ MOST CURRENT ADA _____ MOST CURRENT																																																																																																																																																																																																																																																																																																																																																																																																																																																																																																																																																								
15. THRESHOLD BUILDING CONDITIONS	Yes _____ No _____ X																																																																																																																																																																																																																																																																																																																																																																																																																																																																																																																																																								
16. TOTAL CONSTRUCTED BUILDING AREA	(measured to exterior face of exterior walls) N/A sq.ft.																																																																																																																																																																																																																																																																																																																																																																																																																																																																																																																																																								
<p><b>FIRE SAFETY CODE DATA:</b></p> <ol style="list-style-type: none"> <li>1. CLASSIFICATION OF OCCUPANCY <b>E-Educational</b></li> <li>2. MINIMUM CONSTRUCTION REQUIRED <b>n/a</b></li> <li>3. ACTUAL CONSTRUCTION PROVIDED <b>2B</b></li> <li>4. NOTIFICATION / ALARMS <b>YES X NO _____</b></li> <li>5. DETECTION <b>YES X NO _____</b></li> <li>6. EXTINGUISHING REQUIREMENTS <b>YES X NO _____</b></li> </ol> <p><b>MEANS OF EGRESS</b></p> <p>MAXIMUM FLOOR AREA ALLOWANCES PER OCCUPANT USE FLOOR AREA IN S.F. PER OCCUPANT</p> <ol style="list-style-type: none"> <li>1. CLASSROOMS <b>20 S.F. NET</b></li> <li>2. SHOPS &amp; VOCATIONAL <b>50 S.F. NET</b></li> <li>3. ASSEMBLY WITHOUT FIXED SEATS <b>7 S.F. NET</b> TABLES AND CHAIRS <b>15 S.F. NET</b></li> <li>4. LIBRARY <b>50 S.F. NET</b></li> <li>5. MECHANICAL AREAS <b>300 S.F. GROSS</b></li> <li>6. BUSINESS AREAS <b>100 S.F. GROSS</b></li> </ol> <p>MAXIMUM LENGTH OF EXIT TRAVEL 1. I.B.C. TABLE 1015.1 <b>250 feet</b></p>																																																																																																																																																																																																																																																																																																																																																																																																																																																																																																																																																									
<p><b>KEY PLAN</b> SCALE: NONE</p>			<p><b>Project Title:</b> Window Replacement and Entrances: Booth Hill Elementary School  <b>Architect:</b> SILVER / PETRUCELLI + ASSOCIATES  <b>Address:</b> 3190 Whitney Avenue, Hamden, CT 06518-2340  <b>Phone:</b> Tel. 203 230 9007 Fax. 203 230 8247  <b>Website:</b> silverpetrucci.com</p> <p><b>Drawing Title:</b> General Information &amp; Code Information  <b>Code:</b> G1  <b>Project Number:</b> STATE PROJECT #144-0105 EC/CV  <b>Date:</b> MAY, 24TH 2016  <b>Scale:</b> AS NOTED  <b>Drawn By:</b> CON  <b>Drawing Number:</b> 18.089</p>																																																																																																																																																																																																																																																																																																																																																																																																																																																																																																																																																						

### SYMBOL LEGEND

—	EXISTING TO REMAIN
— — —	EXISTING TO BE REMOVED
	ACCESSIBLE STATION, SINK, OR AREA
	DOOR NUMBER - SEE DOOR SCHEDULE
	ROOM NUMBER - SEE FINISH SCHEDULE
	DEMOLITION NOTES - SEE DWGS.
	WINDOW TYPE - SEE ELEV. ON DWGS.
	ELEVATION OR SECTION NUMBER SHEET NUMBER
	PLAN, SECTION, DETAIL OR ELEV. NUMBER SHEET NUMBER
	EXPANSION JOINT
	H.D.F. HANDICAPPED DRINKING FOUNTAIN
	TB/WB TACKBOARD/WHITEBOARD

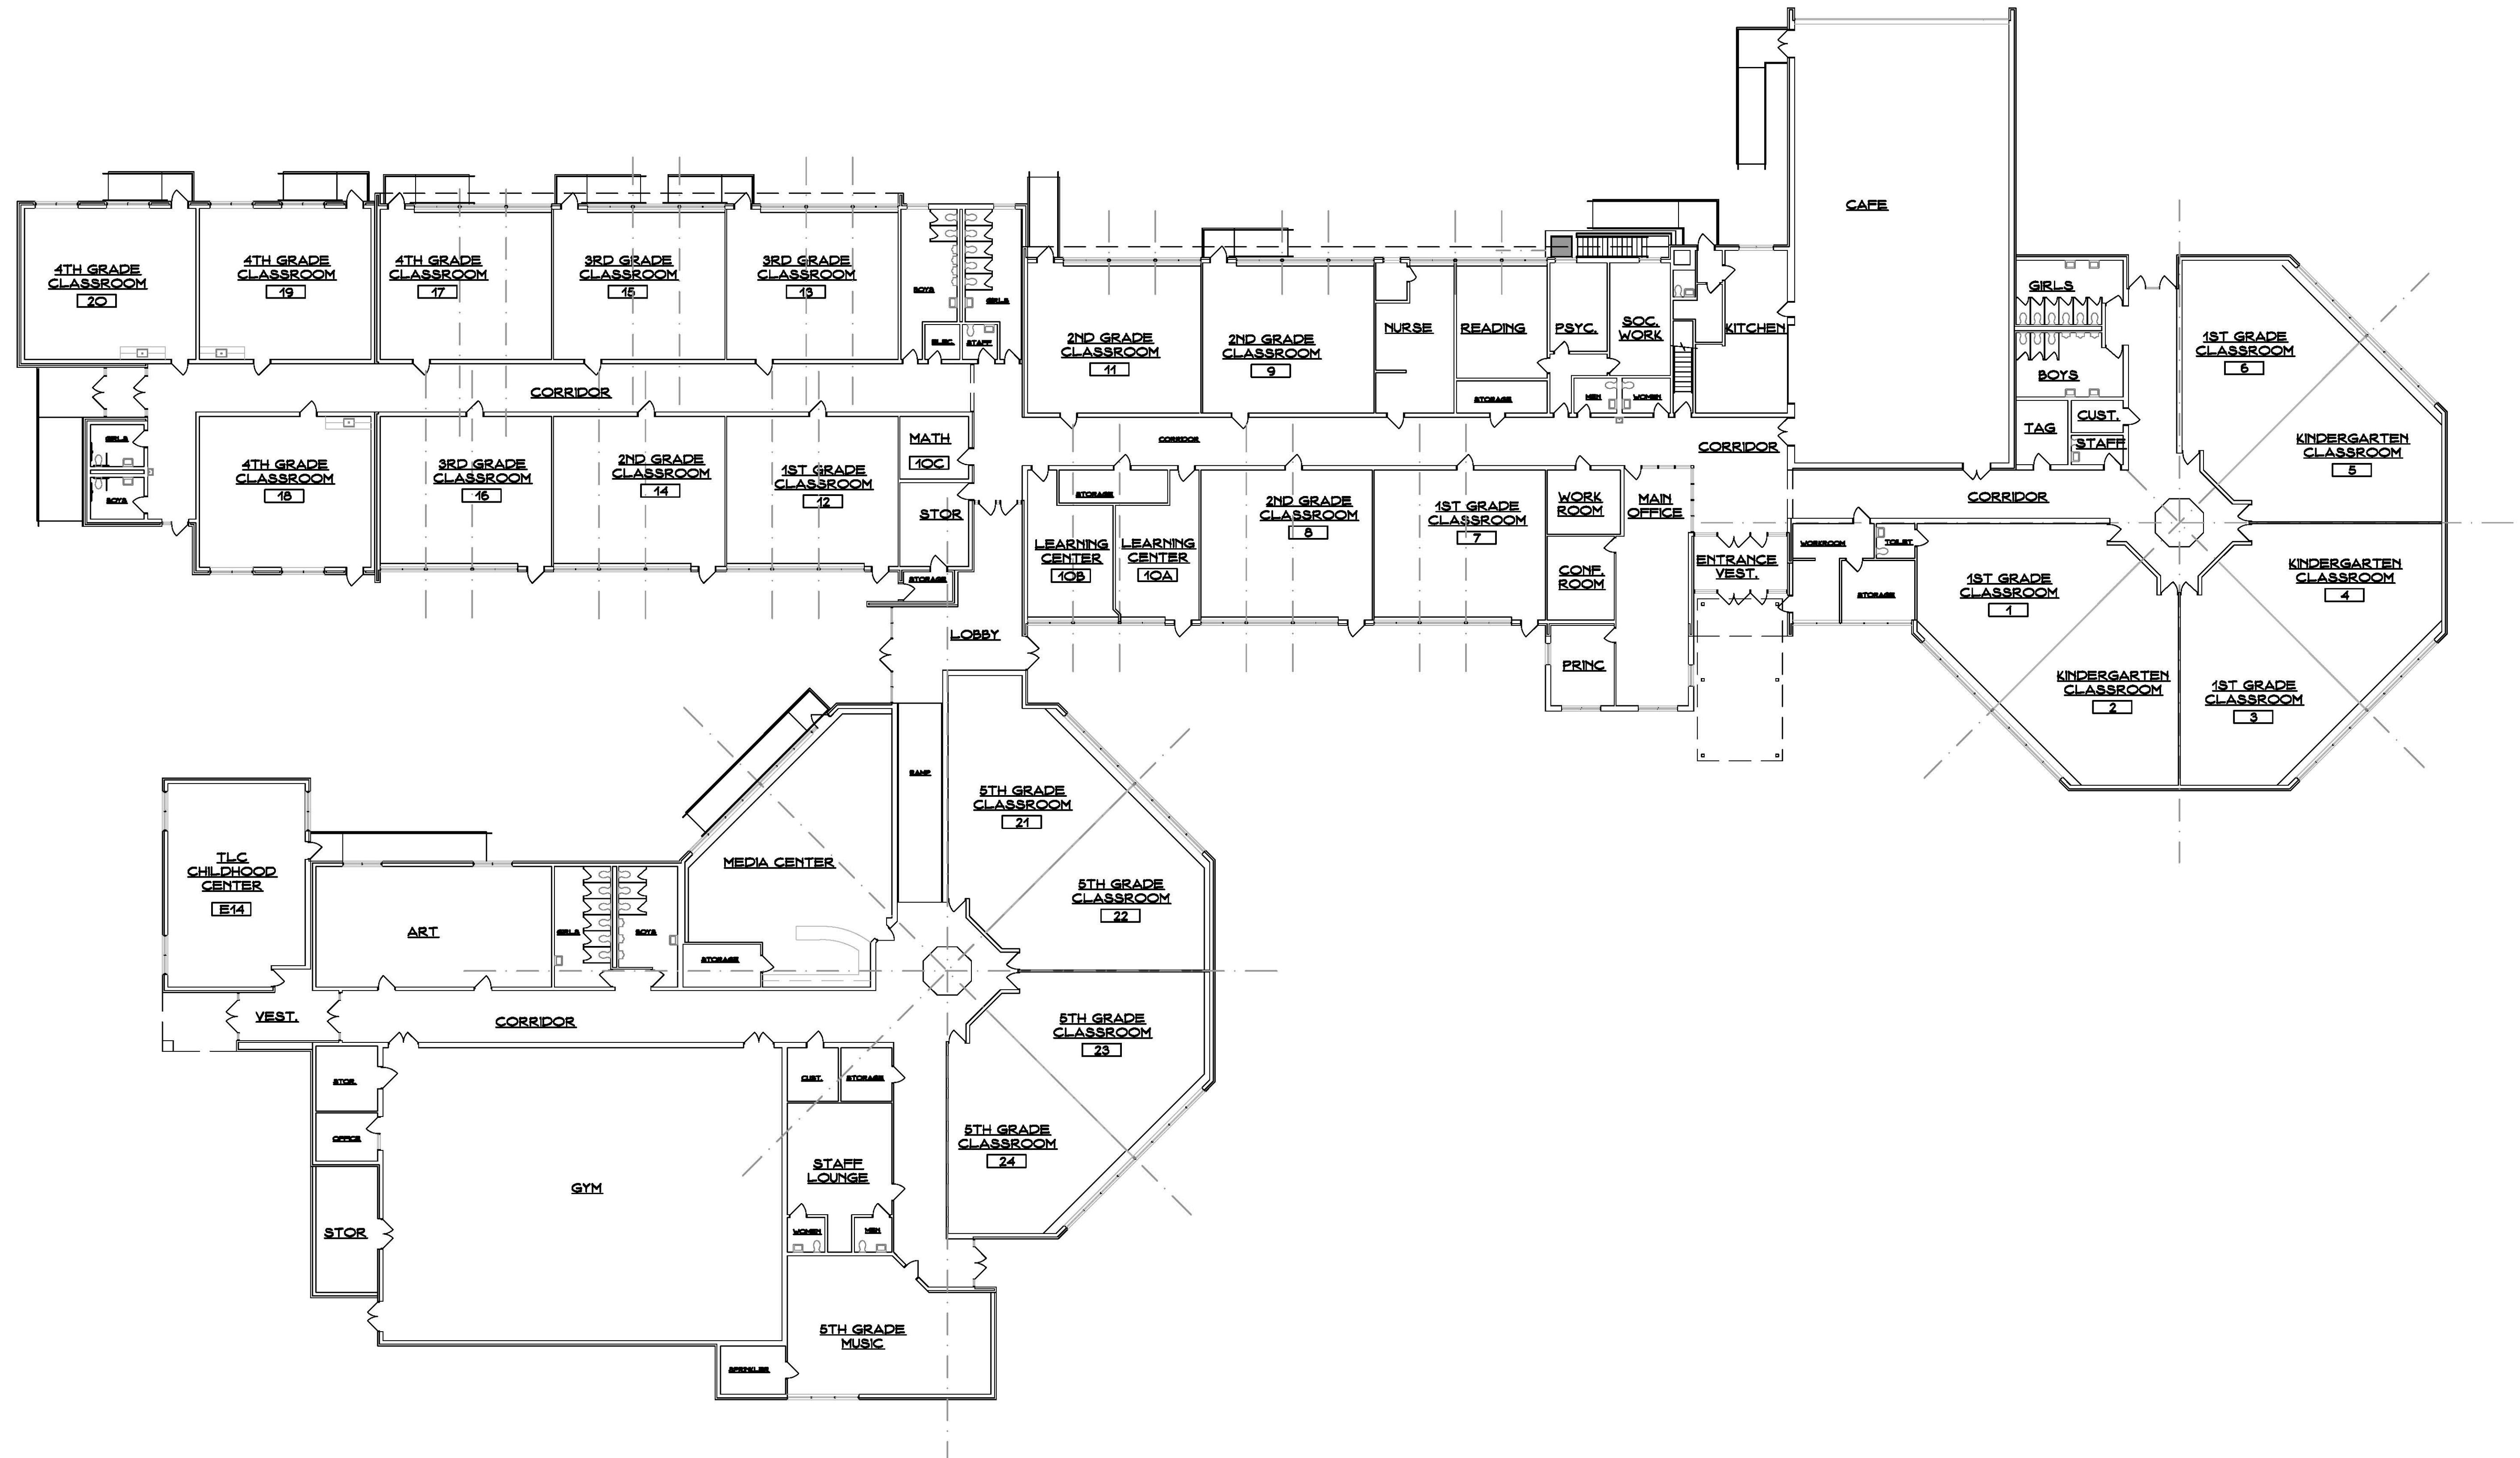

Project Title: Window Replacement and Entrances:  
Booth Hill Elementary School  
544 Booth Hill Road  
Trumbull, Connecticut 06484

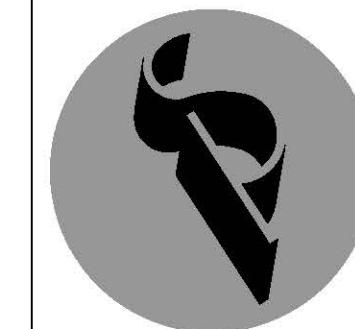

SILVER / PETRUCCIELLO + ASSOCIATES  
Architects / Engineers / Interior Designers  
3190 Whitney Avenue, Hamden, CT 06518-2340  
Tel. 203 230 9007 Fax. 203 230 8247  
silverpetrucciello.com

Revision: Description: Date: Revised By:

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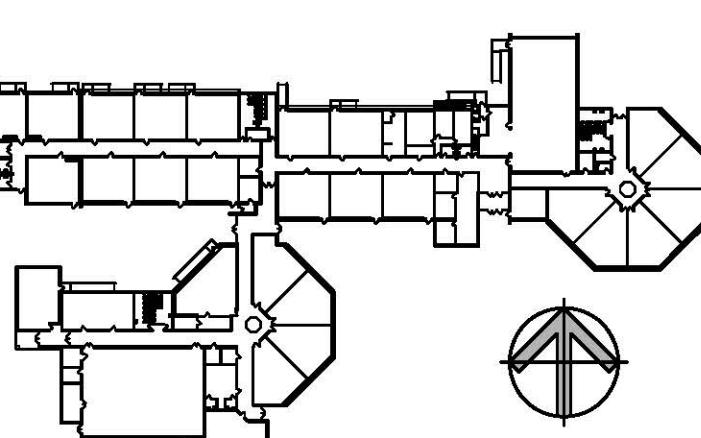
Drawing Title: Existing Floor Plan  
STATE PROJECT #144-0105 EC/CV

Date: MAY, 24TH 2018 Drawing Number:  
Scale: AS NOTED  
Drawn By: CON  
Project Number: 18.089


### GENERAL NOTES

- CONTRACTOR IS RESPONSIBLE TO FIELD VERIFY ALL EXISTING CONDITIONS & DIMENSIONS PRIOR TO CONSTRUCTION.
- CONTRACTOR IS RESPONSIBLE TO REPAIR OR REPLACE ANY AREAS DAMAGED OUTSIDE THE SCOPE OF WORK RETURNING THEM TO THEIR ORIGINAL CONDITION AT NO EXPENSE TO THE OWNER.
- PATCH ALL EXISTING MATERIALS AFFECTED BY NEW CONSTRUCTION IN THIS PROJECT, MATCH EXISTING.
- ALL MATERIALS & EQUIP. ARE NEW UNLESS OTHERWISE NOTED AS EXISTING.
- REMOVE ALL DISMISSED MATERIALS FROM SITE, LEAVE SITE CLEAN OF ALL CONSTRUCTION DUST AND DEBRIS AT THE END OF EACH DAY. CONTRACTOR WILL BE RESPONSIBLE FOR ALL CUSTODIAL TIME ASSOCIATED WITH CLEANING NOT PROVIDED BY CONTRACTOR.
- CONTRACTOR IS RESPONSIBLE TO PLUSH CLEAN AT ALL MASONRY OPENINGS, CUT BACK EX. STEEL, AS REQUIRED.
- CONTRACTOR IS RESPONSIBLE FOR REMOVING, RELOCATING, AND RECONNECTING ANY AND ALL ELEC. EQUIPMENT, DEVICES, CONDUIT AND CABLES AS REQUIRED BY THE SCOPE OF WORK PRIOR TO DEMOLITION AND UPON COMPLETION OF CONSTRUCTION. CONTRACTOR TO VERIFY ALL ASSOCIATED COMPONENTS AFFECTED BY THE SCOPE OF WORK.
- CONTRACTOR IS RESPONSIBLE TO SURVEY AND DOCUMENT EXISTING CONDITIONS PRIOR TO CONSTRUCTION.
- CONTRACTOR IS RESPONSIBLE TO CARRY ALL TRADES IN BD NEEDED TO REMOVE AND REINSTALL ALL OBJECTS ATTACHED TO EXISTING BRICK VENEER, AFFECTED BY SCOPE OF WORK (IE. ROOF LADDERS, EXHAUST, LOUVERS, SIGNAGE, LIGHTING SYSTEMS, ELEC. CONDUIT, AND ANY OTHER MISC. ITEMS).
- CONTRACTOR TO COORDINATE AND REFERENCE EACH DISCIPLINE WITHIN THE DRAWINGS SET PRIOR & DURING CONSTRUCTION.
- ANY EXISTING CONSTRUCTION ACTIVITY WHICH WOULD IMPACT LEAD AND/OR ASBESTOS (TOXIC/TOX) MUST BE CONDUCTED WITHIN COMPLIANCE AND TO CODE REQUIREMENTS (SEE PROJ. MAN.)

### KEY PLAN SCALE: NONE



A1

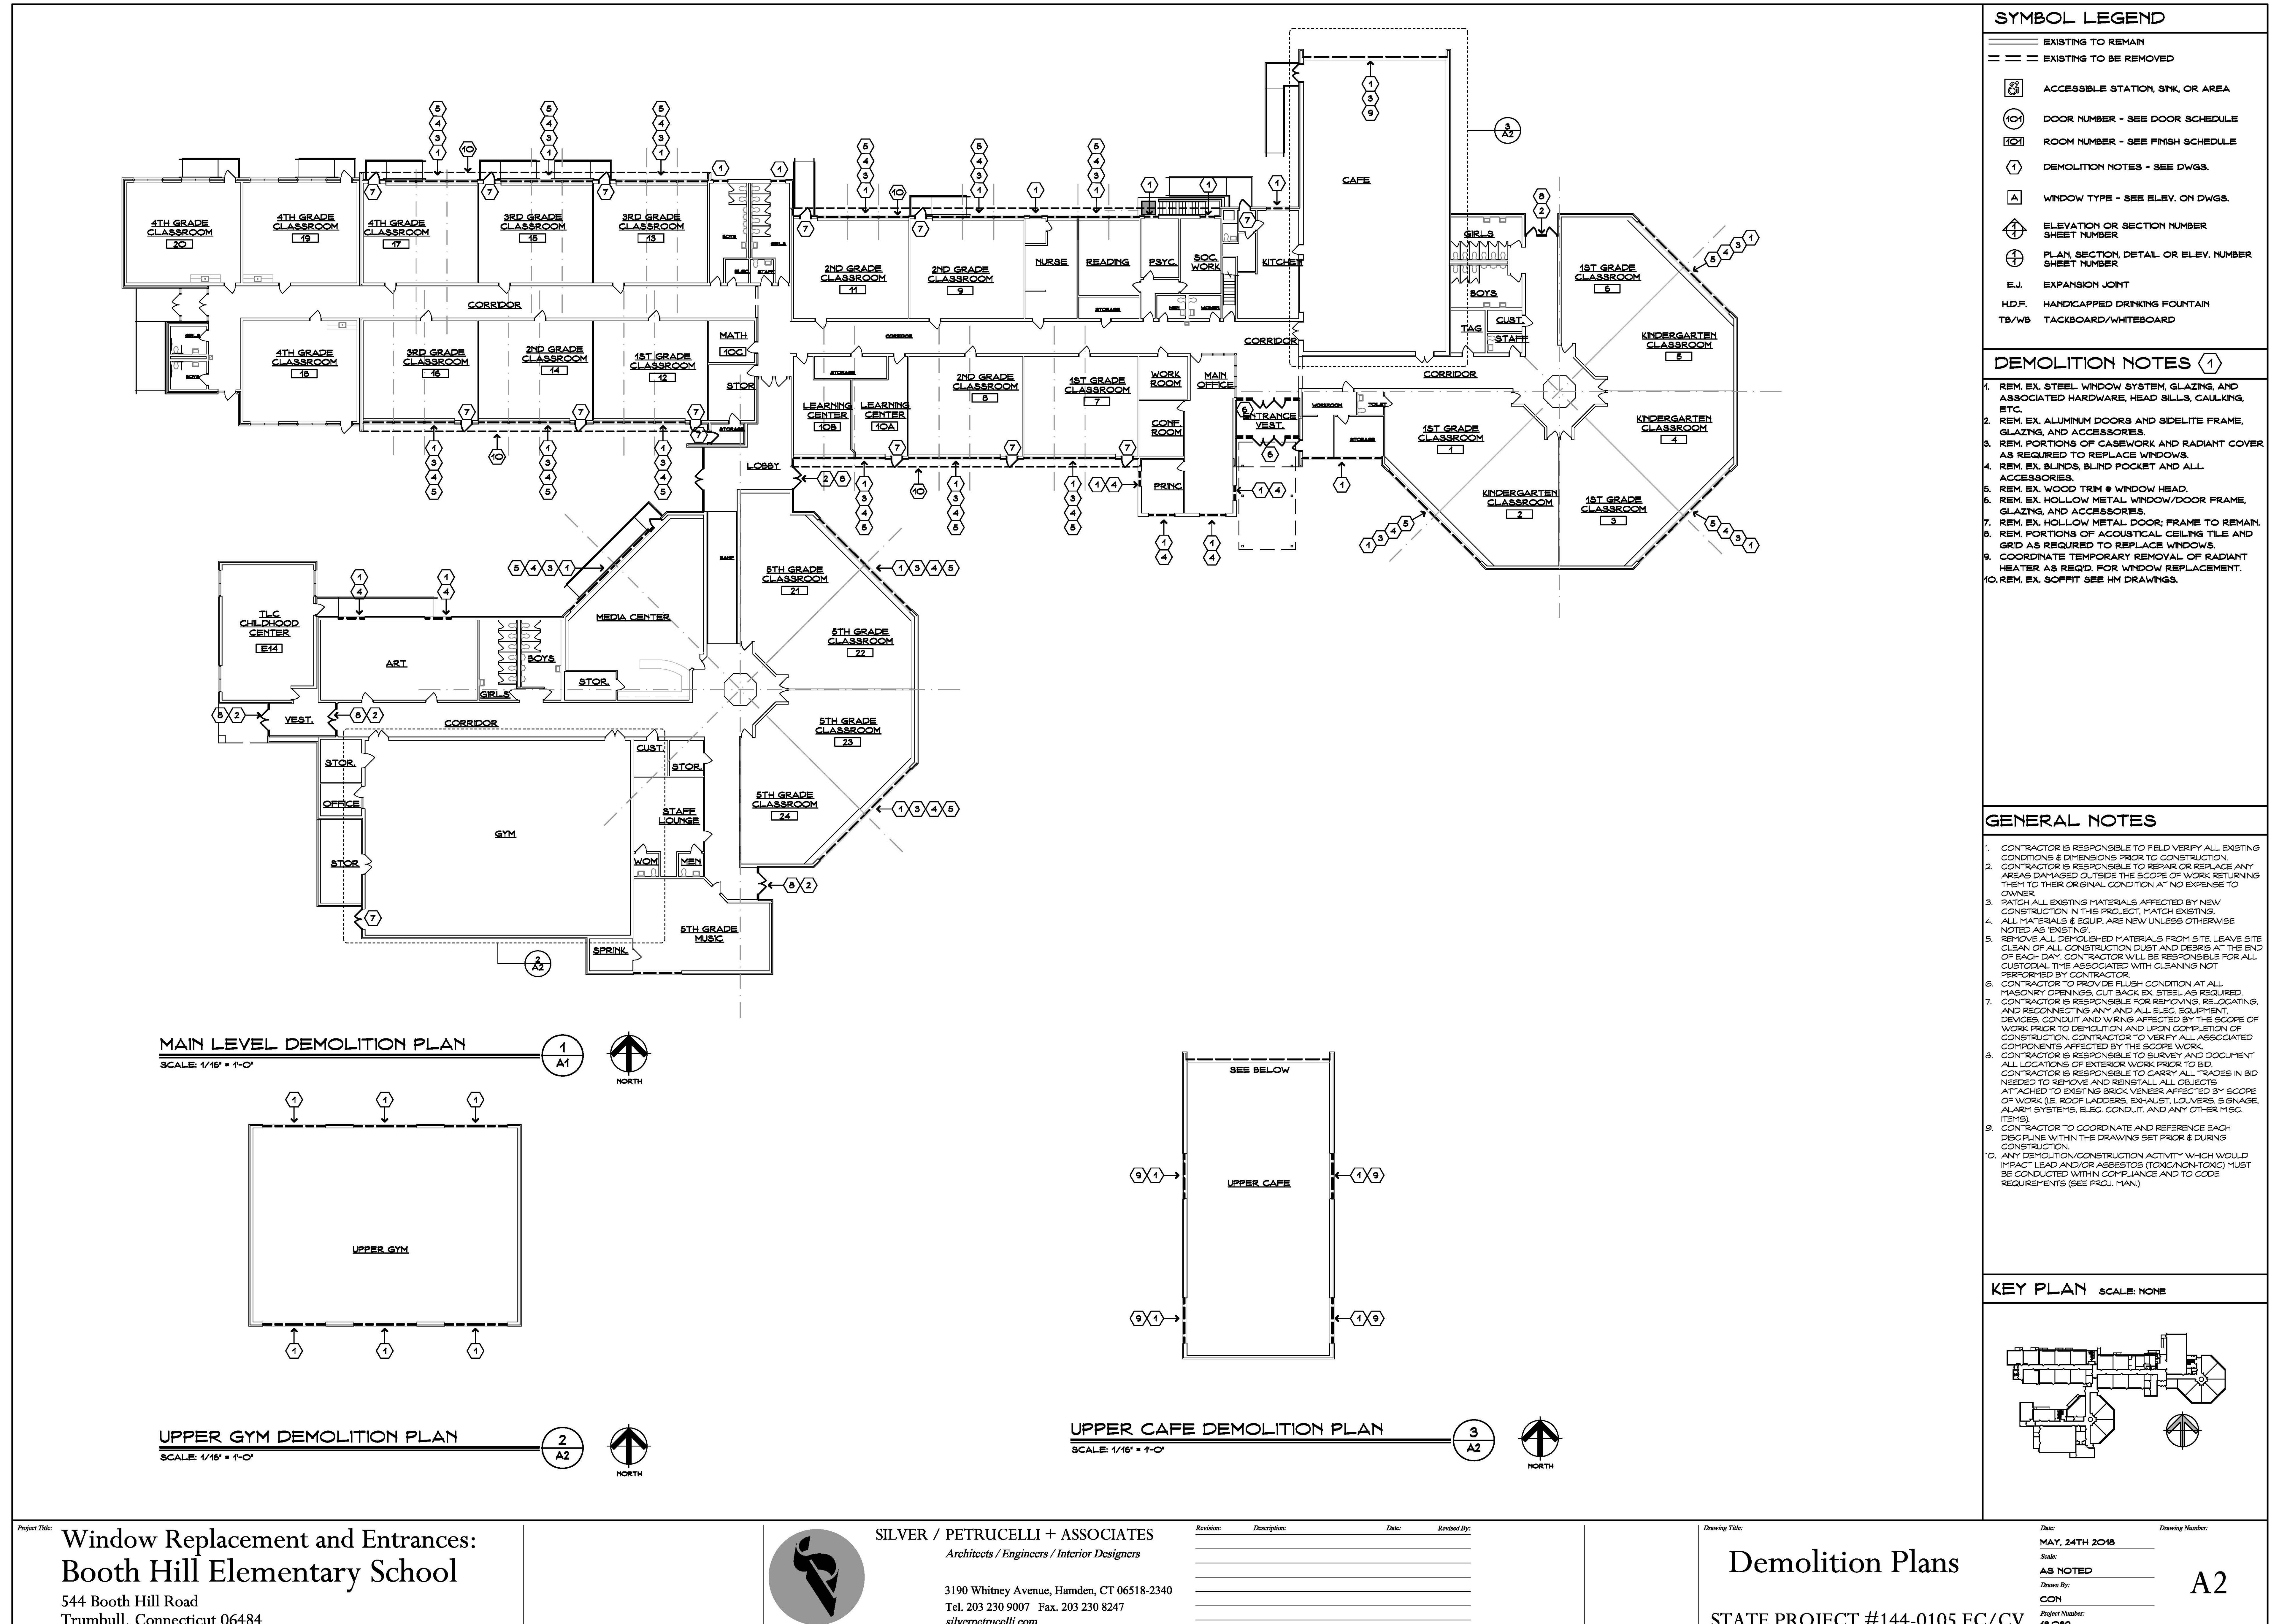

**OVERALL EXISTING DEMOLITION PLAN** 1 A3

SCALE: 1/16" = 1'-0" NORTH

**UPPER GYM FLOOR PLAN** 2 A3

SCALE: 1/16" = 1'-0" NORTH

**UPPER CAFE DEMOLITION PLAN** 3 A3

SCALE: 1/16" = 1'-0" NORTH

**SEE BELOW**

**GENERAL NOTES**

1. THERMALLY BROKEN ALUMINUM WINDOW SYSTEM ASSEMBLY:
  - FRAME, SILL, GLAZING, OPERABLE, TRIM & BLOCKING & ASSOCIATED COMPONENTS (PER MANUFACTURER). SEE WINDOW TYPES & PROJECT MANUAL FOR ADDITIONAL INFORMATION.
  - SAND, PRIME & PAINT ALL EXPOSED STL LINTELS.
  - REINSTALL EXISTING RADIATOR GRILLE - SAND, PRIME & PAINT (PROVIDE BLOCKING/CLEAT AS REQ'D).
2. WINDOW BLINDS/SHADE/ROLLER SYSTEM:
  - INSTALL ON NEW WOOD TRIM. PROVIDE ALTERNATE FOR ROLLER SHADES. SEE PROJ. MAN.
  - PROVIDE METAL FLASHING ALONG EDGES OF NEW WINDOW.
  - MATCH PROFILE, LENGTH, DEPTH REQUIRED TO INSTALL NEW METAL FLASHING. PROVIDE NEW BLOCKING AS REQUIRED FOR INSTALLATION.
  - WRAP EXISTING SLATE SILLS WITH Drip EDGE UNDERNEATH SILL EXTENSION - SEE DETAILS.
3. PROVIDE HOLLOW METAL FLASHING ALONG EDGES OF NEW WOOD DOORS.
4. PROVIDE HOLLOW METAL DOORS.
5. PROVIDE NEW HOLLOW METAL WITHIN EXISTING FRAMED OPENINGS. (SEE DOOR SCHEDULE FOR APPROX. SIZES TO BE VERIFIED IN FIELD) SAND, SCRAPE, PAINT, AND PATCH EXISTING HOLLOW METAL FRAMES.
6. NEW ENTRANCE FRAMES:
  - PROVIDE ENTRANCE FRAMES TO MATCH ALUMINUM WINDOW FRAMING SYSTEM.
  - PROVIDE 1-1/2" DIA. BOLTS PER ELEVATIONS, DOOR SCHEDULE, AND PROJ. MAN.
  - PROVIDE UPGRADE ENTRANCE FRAME AT MAIN ENTRANCE - SEE ELEVATIONS AND PROJ. MAN. FOR SPECIAL GLAZING REQUIREMENTS.
7. NO BLINDS IN THIS LOCATION.
8. SPECIAL OVERSIZED VERTICAL BLINDS REQUIRED THIS LOCATION.
9. INSTALL BLOCKING, FRAMING, AND NEW SOFFIT AT WINDOW HEAD SEE DETAIL ON A7
10. PROVIDE TEN (10) SIGNS TO BE MOUNTED TO INSIDE OF DOOR GLASS AND WINDOWS FOR LARGE SPACES - SEE DET. ON DWG. A9.

**KEY PLAN** SCALE: NONE

**SILVER / PETRUCELLI + ASSOCIATES**  
Architects / Engineers / Interior Designers  
3190 Whitney Avenue, Hamden, CT 06518-2340  
Tel. 203 230 9007 Fax. 203 230 8247  
silverpetrucci.com

**Project Title:** Window Replacement and Entrances:  
Booth Hill Elementary School  
544 Booth Hill Road  
Trumbull, Connecticut 06484

**Floor Plans** Drawing Title: A3

**STATE PROJECT #144-0105 EC/CV** Drawing Number: 18.089

**Symbol Legend**

— EXISTING TO REMAIN  
— EXISTING TO BE REMOVED


① ACCESSIBLE STATION, SINK, OR AREA  
② DOOR NUMBER - SEE DOOR SCHEDULE  
③ ROOM NUMBER - SEE FINISH SCHEDULE  
④ DEMOLITION NOTES - SEE DWGS.  
⑤ WINDOW TYPE - SEE ELEV. ON DWGS.  
⑥ ELEVATION OR SECTION NUMBER  
⑦ SHEET NUMBER  
⑧ PLAN, SECTION, DETAIL OR ELEV. NUMBER  
⑨ SHEET NUMBER  
⑩ EXPANSION JOINT  
⑪ HANDICAPPED DRINKING FOUNTAIN  
⑫ TACKBOARD/WHITEBOARD

**Construction Notes**


1. THERMALLY BROKEN ALUMINUM WINDOW SYSTEM ASSEMBLY:
  - FRAME, SILL, GLAZING, OPERABLE, TRIM & BLOCKING & ASSOCIATED COMPONENTS (PER MANUFACTURER). SEE WINDOW TYPES & PROJECT MANUAL FOR ADDITIONAL INFORMATION.
  - SAND, PRIME & PAINT ALL EXPOSED STL LINTELS.
  - REINSTALL EXISTING RADIATOR GRILLE - SAND, PRIME & PAINT (PROVIDE BLOCKING/CLEAT AS REQ'D).
2. WINDOW BLINDS/SHADE/ROLLER SYSTEM:
  - INSTALL ON NEW WOOD TRIM. PROVIDE ALTERNATE FOR ROLLER SHADES. SEE PROJ. MAN.
  - PROVIDE METAL FLASHING ALONG EDGES OF NEW WINDOW.
  - MATCH PROFILE, LENGTH, DEPTH REQUIRED TO INSTALL NEW METAL FLASHING. PROVIDE NEW BLOCKING AS REQUIRED FOR INSTALLATION.
  - WRAP EXISTING SLATE SILLS WITH Drip EDGE UNDERNEATH SILL EXTENSION - SEE DETAILS.
3. PROVIDE HOLLOW METAL FLASHING ALONG EDGES OF NEW WOOD DOORS.
4. PROVIDE HOLLOW METAL DOORS.
5. PROVIDE NEW HOLLOW METAL WITHIN EXISTING FRAMED OPENINGS. (SEE DOOR SCHEDULE FOR APPROX. SIZES TO BE VERIFIED IN FIELD) SAND, SCRAPE, PAINT, AND PATCH EXISTING HOLLOW METAL FRAMES.
6. NEW ENTRANCE FRAMES:
  - PROVIDE ENTRANCE FRAMES TO MATCH ALUMINUM WINDOW FRAMING SYSTEM.
  - PROVIDE 1-1/2" DIA. BOLTS PER ELEVATIONS, DOOR SCHEDULE, AND PROJ. MAN.
  - PROVIDE UPGRADE ENTRANCE FRAME AT MAIN ENTRANCE - SEE ELEVATIONS AND PROJ. MAN. FOR SPECIAL GLAZING REQUIREMENTS.
7. NO BLINDS THIS LOCATION.
8. SPECIAL OVERSIZED VERTICAL BLINDS REQUIRED THIS LOCATION.
9. INSTALL BLOCKING, FRAMING, AND NEW SOFFIT AT WINDOW HEAD SEE DETAIL ON A7
10. PROVIDE TEN (10) SIGNS TO BE MOUNTED TO INSIDE OF DOOR GLASS AND WINDOWS FOR LARGE SPACES - SEE DET. ON DWG. A9.

**GENERAL NOTES**

1. CONTRACTOR IS RESPONSIBLE TO FIELD VERIFY ALL EXISTING CONDITIONS & DIMENSIONS PRIOR TO CONSTRUCTION.
2. CONTRACTOR IS RESPONSIBLE TO REPAIR OR REPLACE ANY AREAS DAMAGED OUTSIDE THE SCOPE OF WORK RETURNING THEM TO THEIR ORIGINAL CONDITION AT NO EXPENSE TO OWNER.
3. PATCH ALL EXISTING MATERIALS AFFECTED BY NEW CONSTRUCTION IN THIS PROJECT MATCH EXISTING.
4. ALL MATERIALS & EQUIP. ARE NEW UNLESS OTHERWISE NOTED. AS EXISTING.
5. REMOVE ALL DEMOLISHED MATERIALS FROM SITE. LEAVE SITE CLEAN OF ALL CONSTRUCTION DUST AND DEBRIS AT THE END OF EACH DAY. CONTRACTOR WILL BE RESPONSIBLE FOR ALL CUSTOMERS ASSOCIATED WITH CLEANING NOT PROVIDED BY CONTRACTOR.
6. CONTRACTOR TO PROVIDE FLUSH CONDITION AT ALL MASONRY OPENINGS. CUT BACK EX. STEEL, AS REQUIRED.
7. CONTRACTOR IS RESPONSIBLE FOR REMOVING, RELOCATING, AND RECONSTRUCTING ANY AND ALL EXISTING EQUIPMENT AND CONDUIT AS IT IS AFFECTED BY THE SCOPE OF WORK PRIOR TO DEMOLITION AND UPON COMPLETION OF CONSTRUCTION. CONTRACTOR TO VERIFY ALL ASSOCIATED COMPONENTS AFFECTED BY THE SCOPE OF WORK.
8. CONTRACTOR TO PROVIDE A BRIEF BRIEF DOCUMENT ALL LOCATIONS OF EXTERIOR WORK PRIOR TO BID. CONTRACTOR IS RESPONSIBLE TO CARRY ALL TRADES IN BID NEEDED TO REMOVE AND REINSTALL ALL OBJECTS ATTACHED TO EXISTING BRICK VENEER AFFECTED BY SCOPE OF WORK (IE. ROOF LADDERS, EXHAUST, LOUVERS, SIGNAGE, ALARM SYSTEMS, ELEC. CONDUIT, AND ANY OTHER MSC. ITEMS).
9. CONTRACTOR TO COORDINATE AND REFERENCE EACH DISCIPLINE WITHIN THE DRAWING SET PRIOR & DURING CONSTRUCTION.
10. ANY DEMOLITION/CONSTRUCTION ACTIVITY WHICH WOULD IMPACT LEAD AND/OR ASBESTOS (TOXIC/NON-TOXIC) MUST BE CONDUCTED WITHIN COMPLIANCE AND TO CODE REQUIREMENTS (SEE PROJ. MAN.)

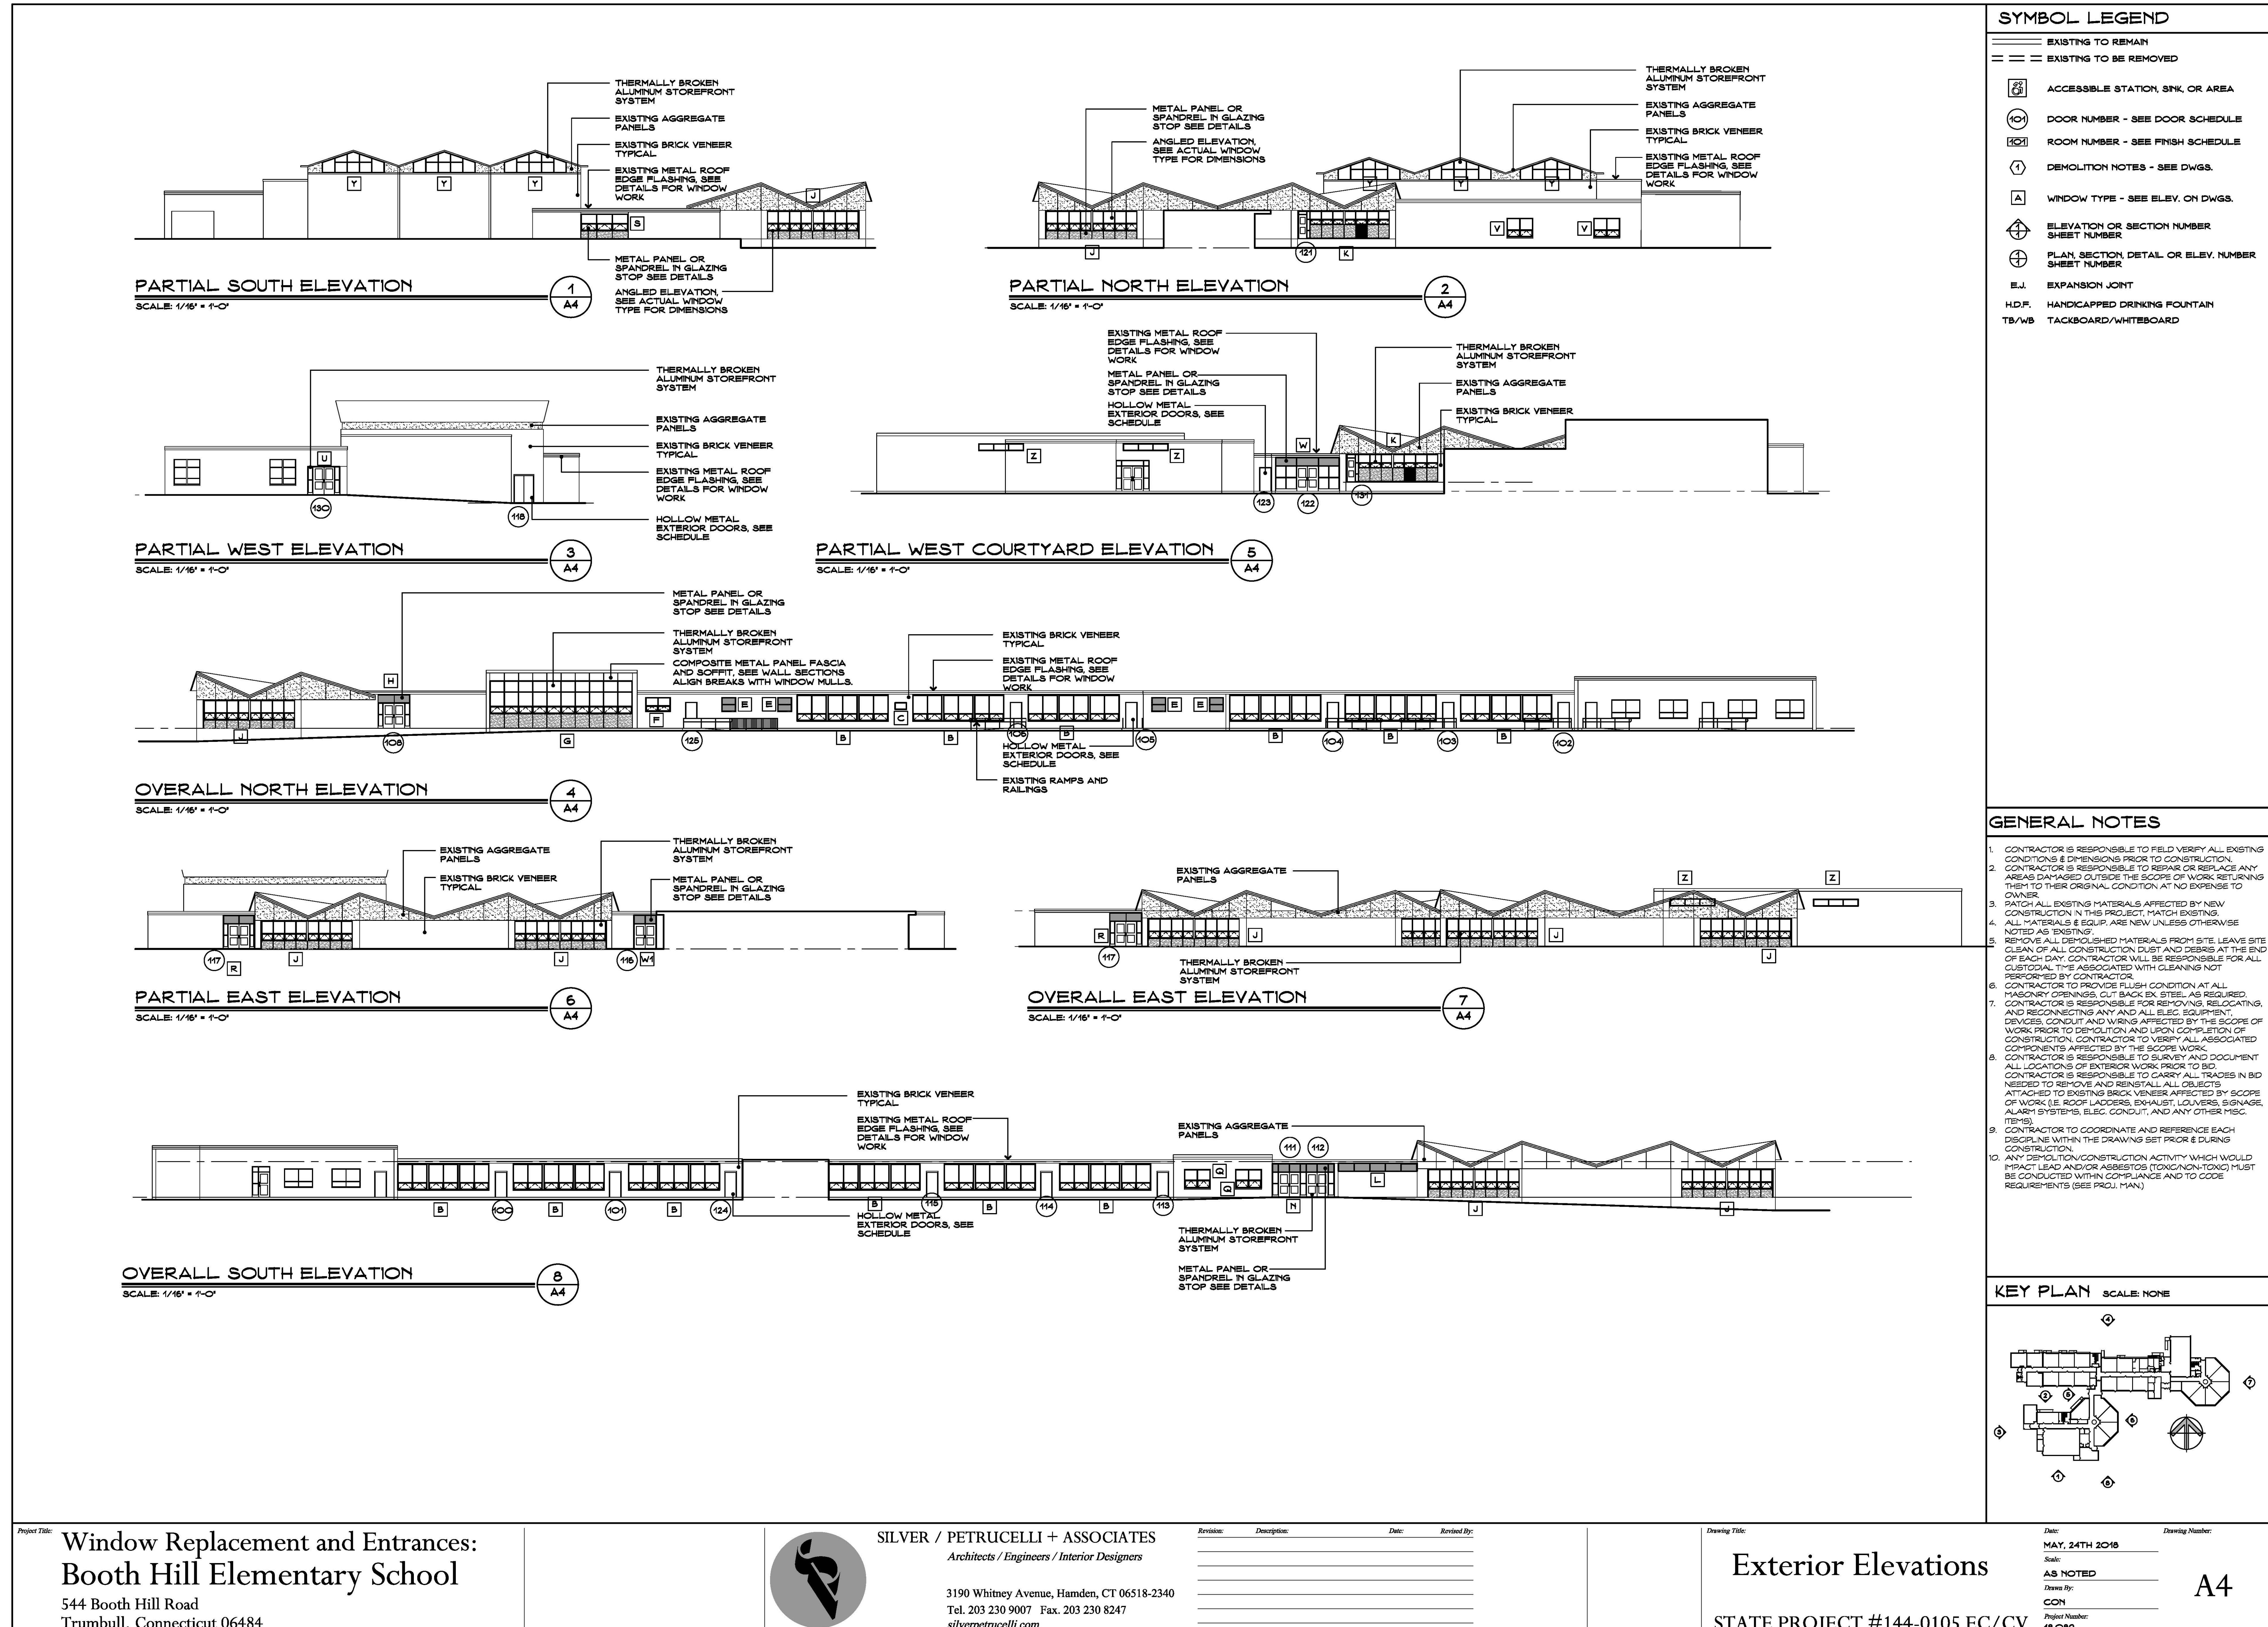

*Project Title:* Window Replacement and Entrances:  
Booth Hill Elementary School

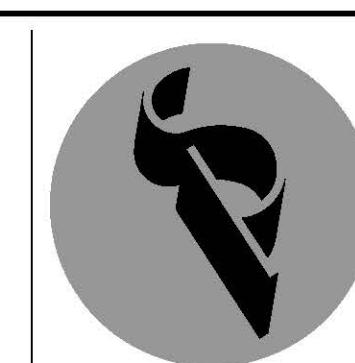


**SILVER / PETRUCCELLI + ASSOCIATES**  
*Architects / Engineers / Interior Designers*

*Drawing Title:*


# Exterior Elevations

## STATE PROJECT #144-0105 EC/

*Date:* MAY, 24TH 2018 *Drawing Number:*  
*Scale:* AS NOTED *Drawn By:* CON *Project Number:* 18-082  
**A4**

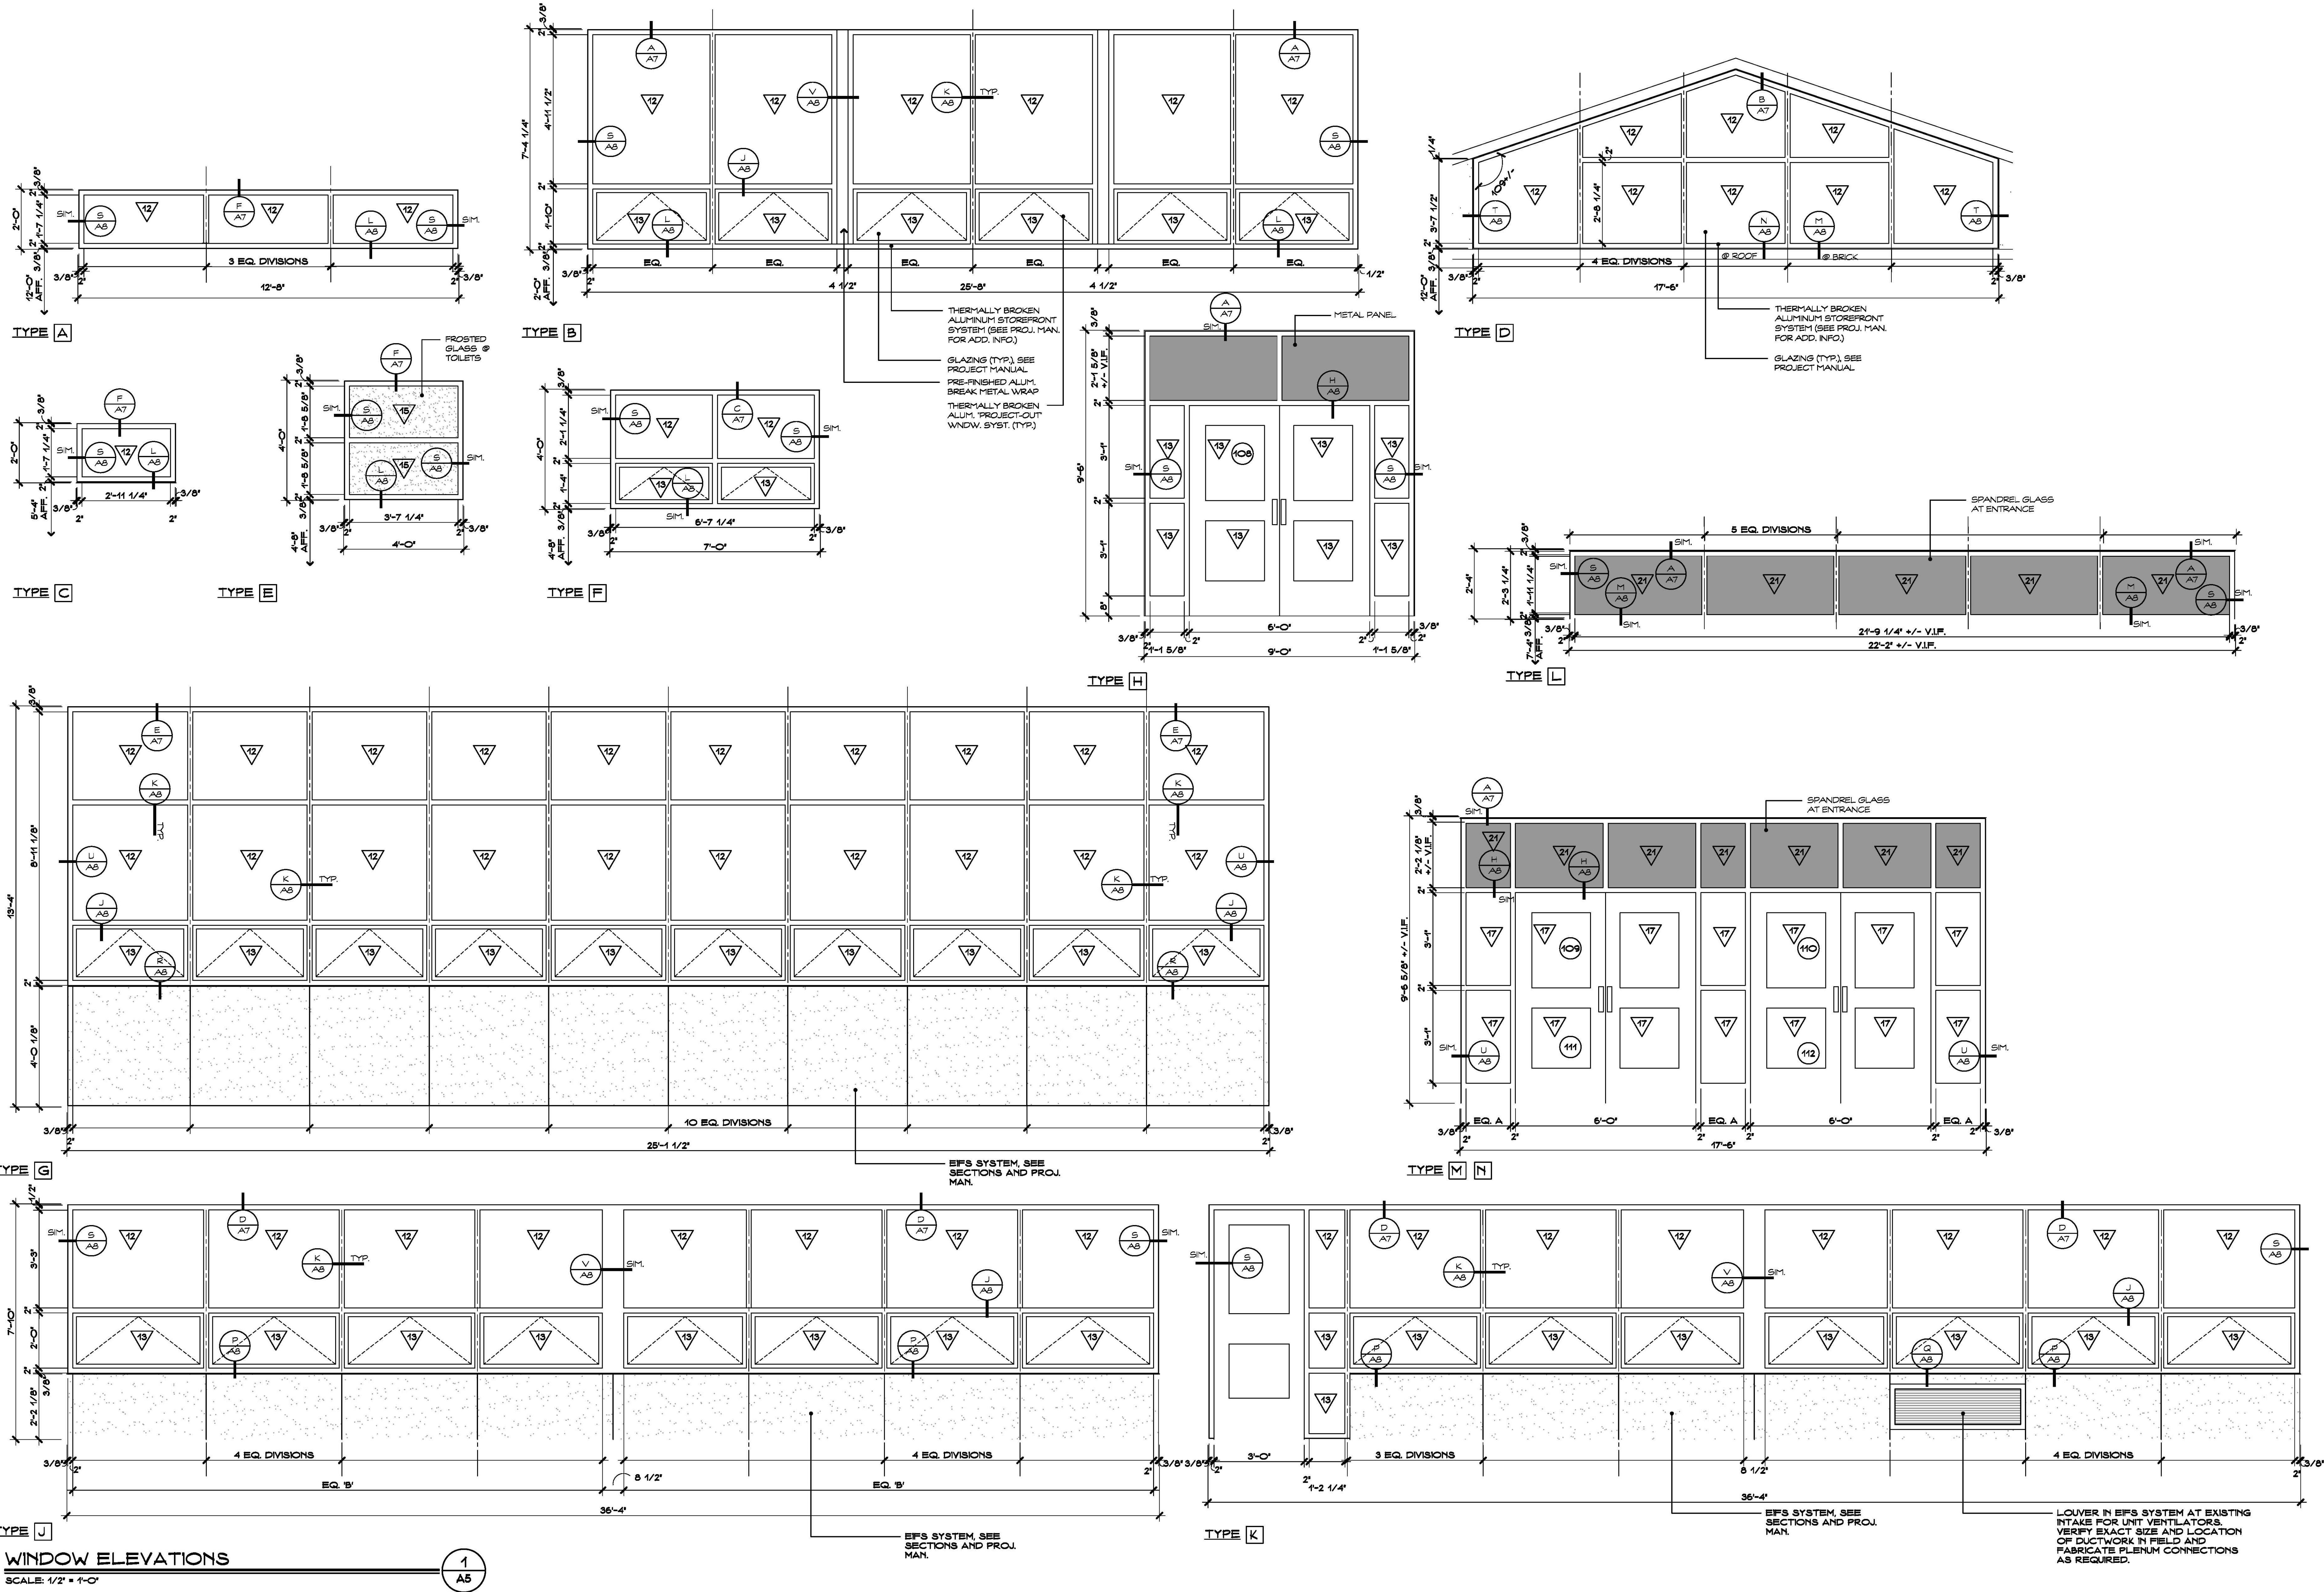

*Project Title:* **Window Replacement and Entrances  
Booth Hill Elementary School**

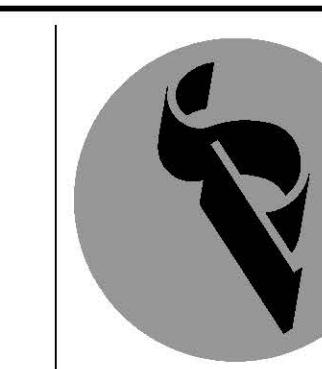



**SILVER / PETRUCCELLI + ASSOCIATES**  
*Architects / Engineers / Interior Designers*

*Drawing Title:*


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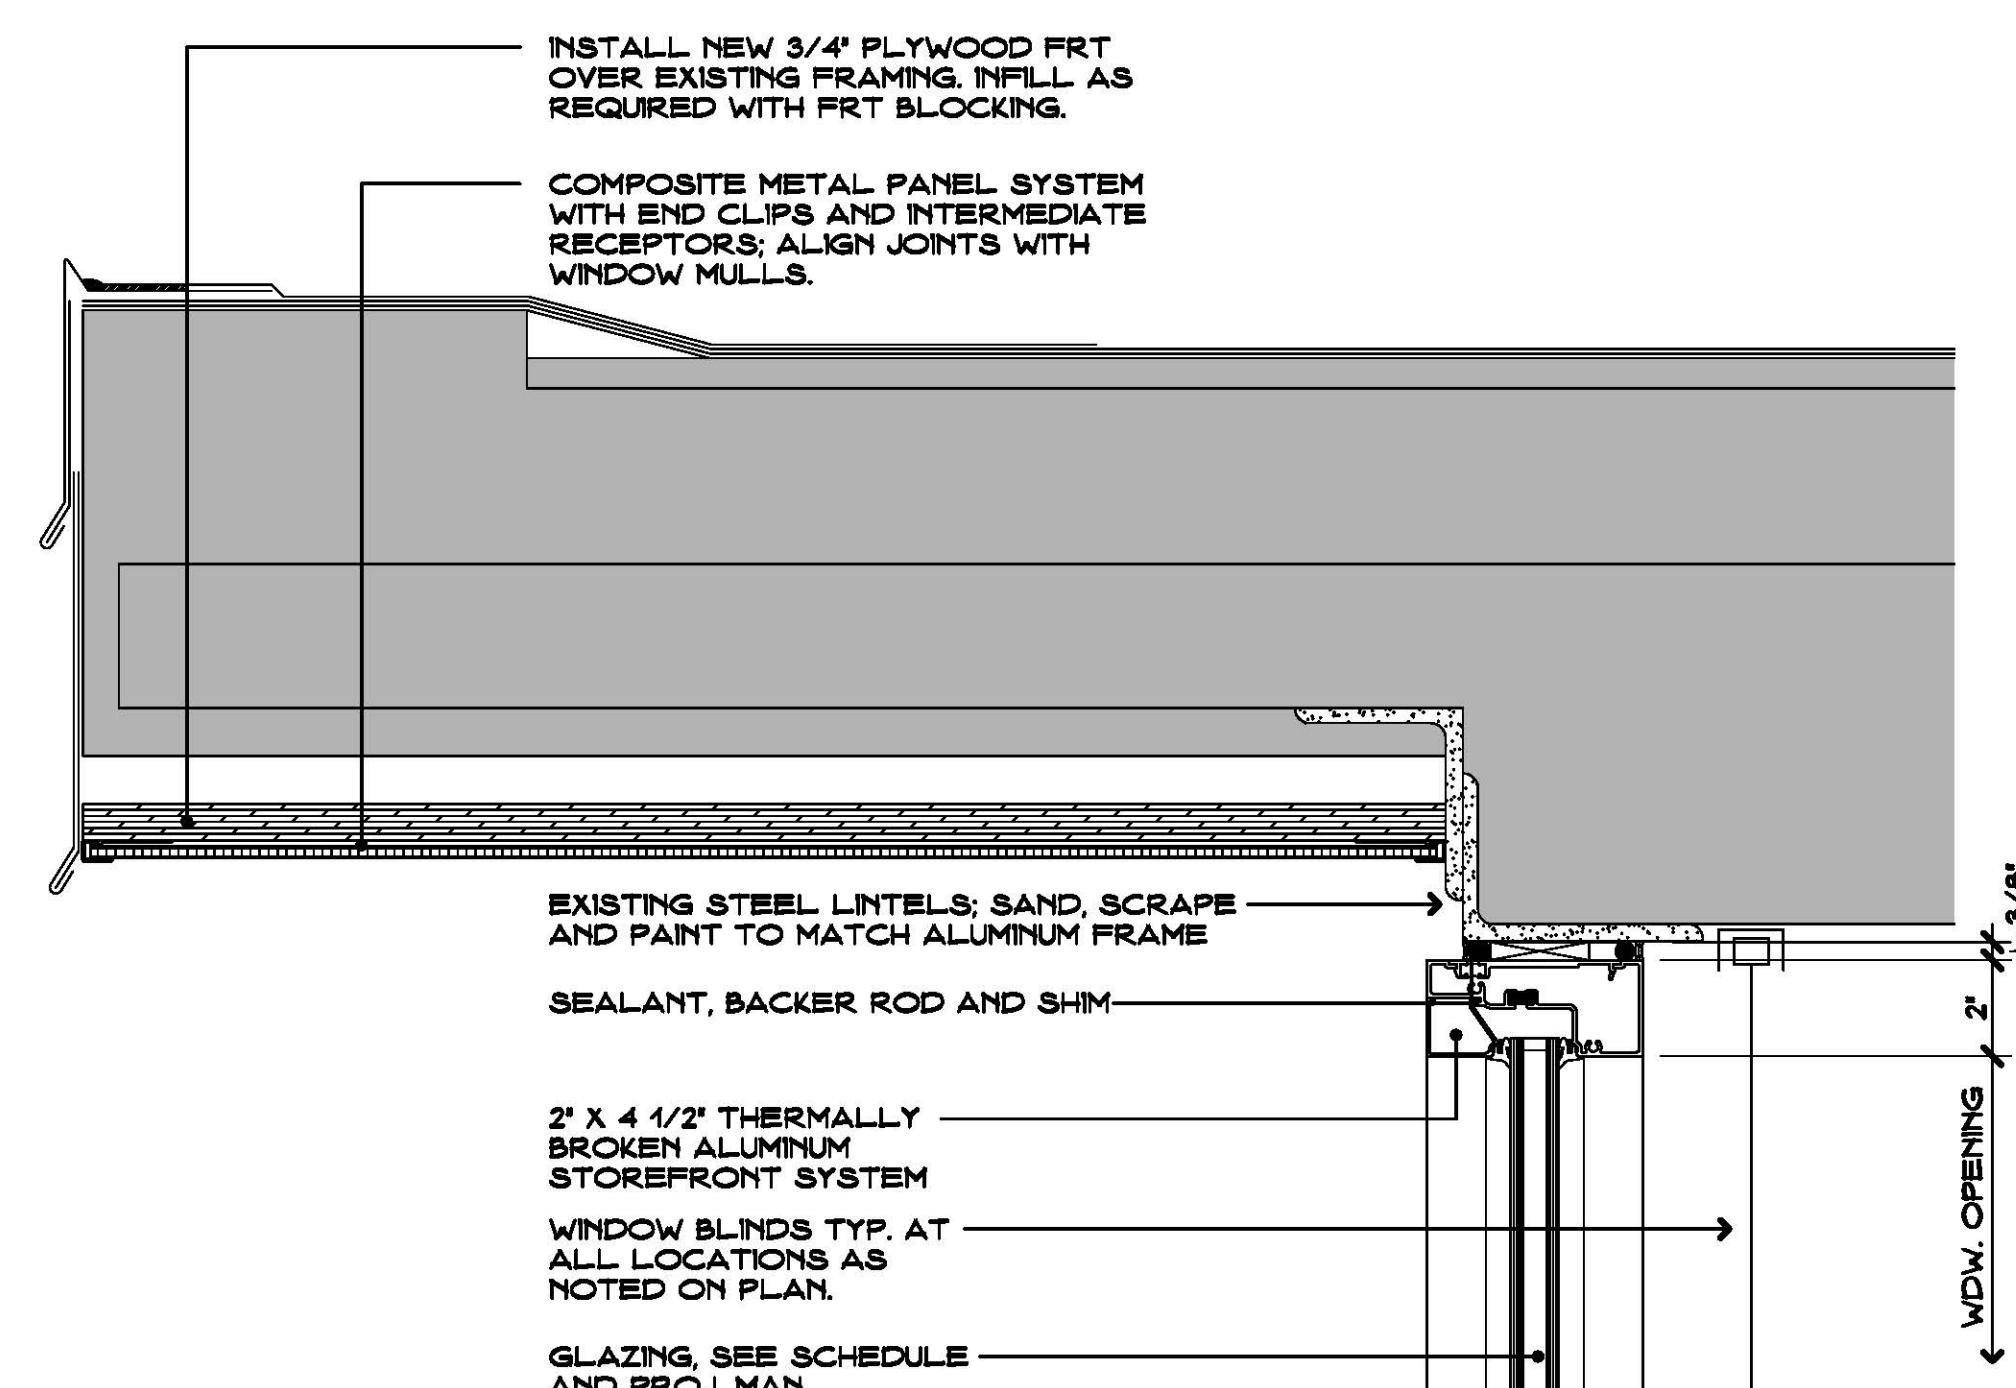
STATE PROJECT #144-0105 EC/C

*Date:* MAY, 24TH 2018 *Drawing Number:*  
*Scale:* AS NOTED *Drawn By:* CON *Project Number:* 18.089  
**A5**

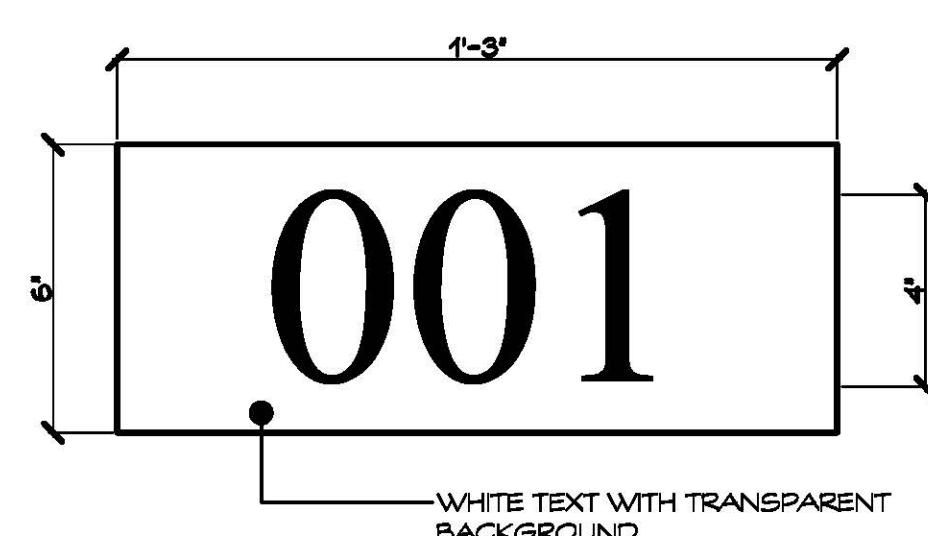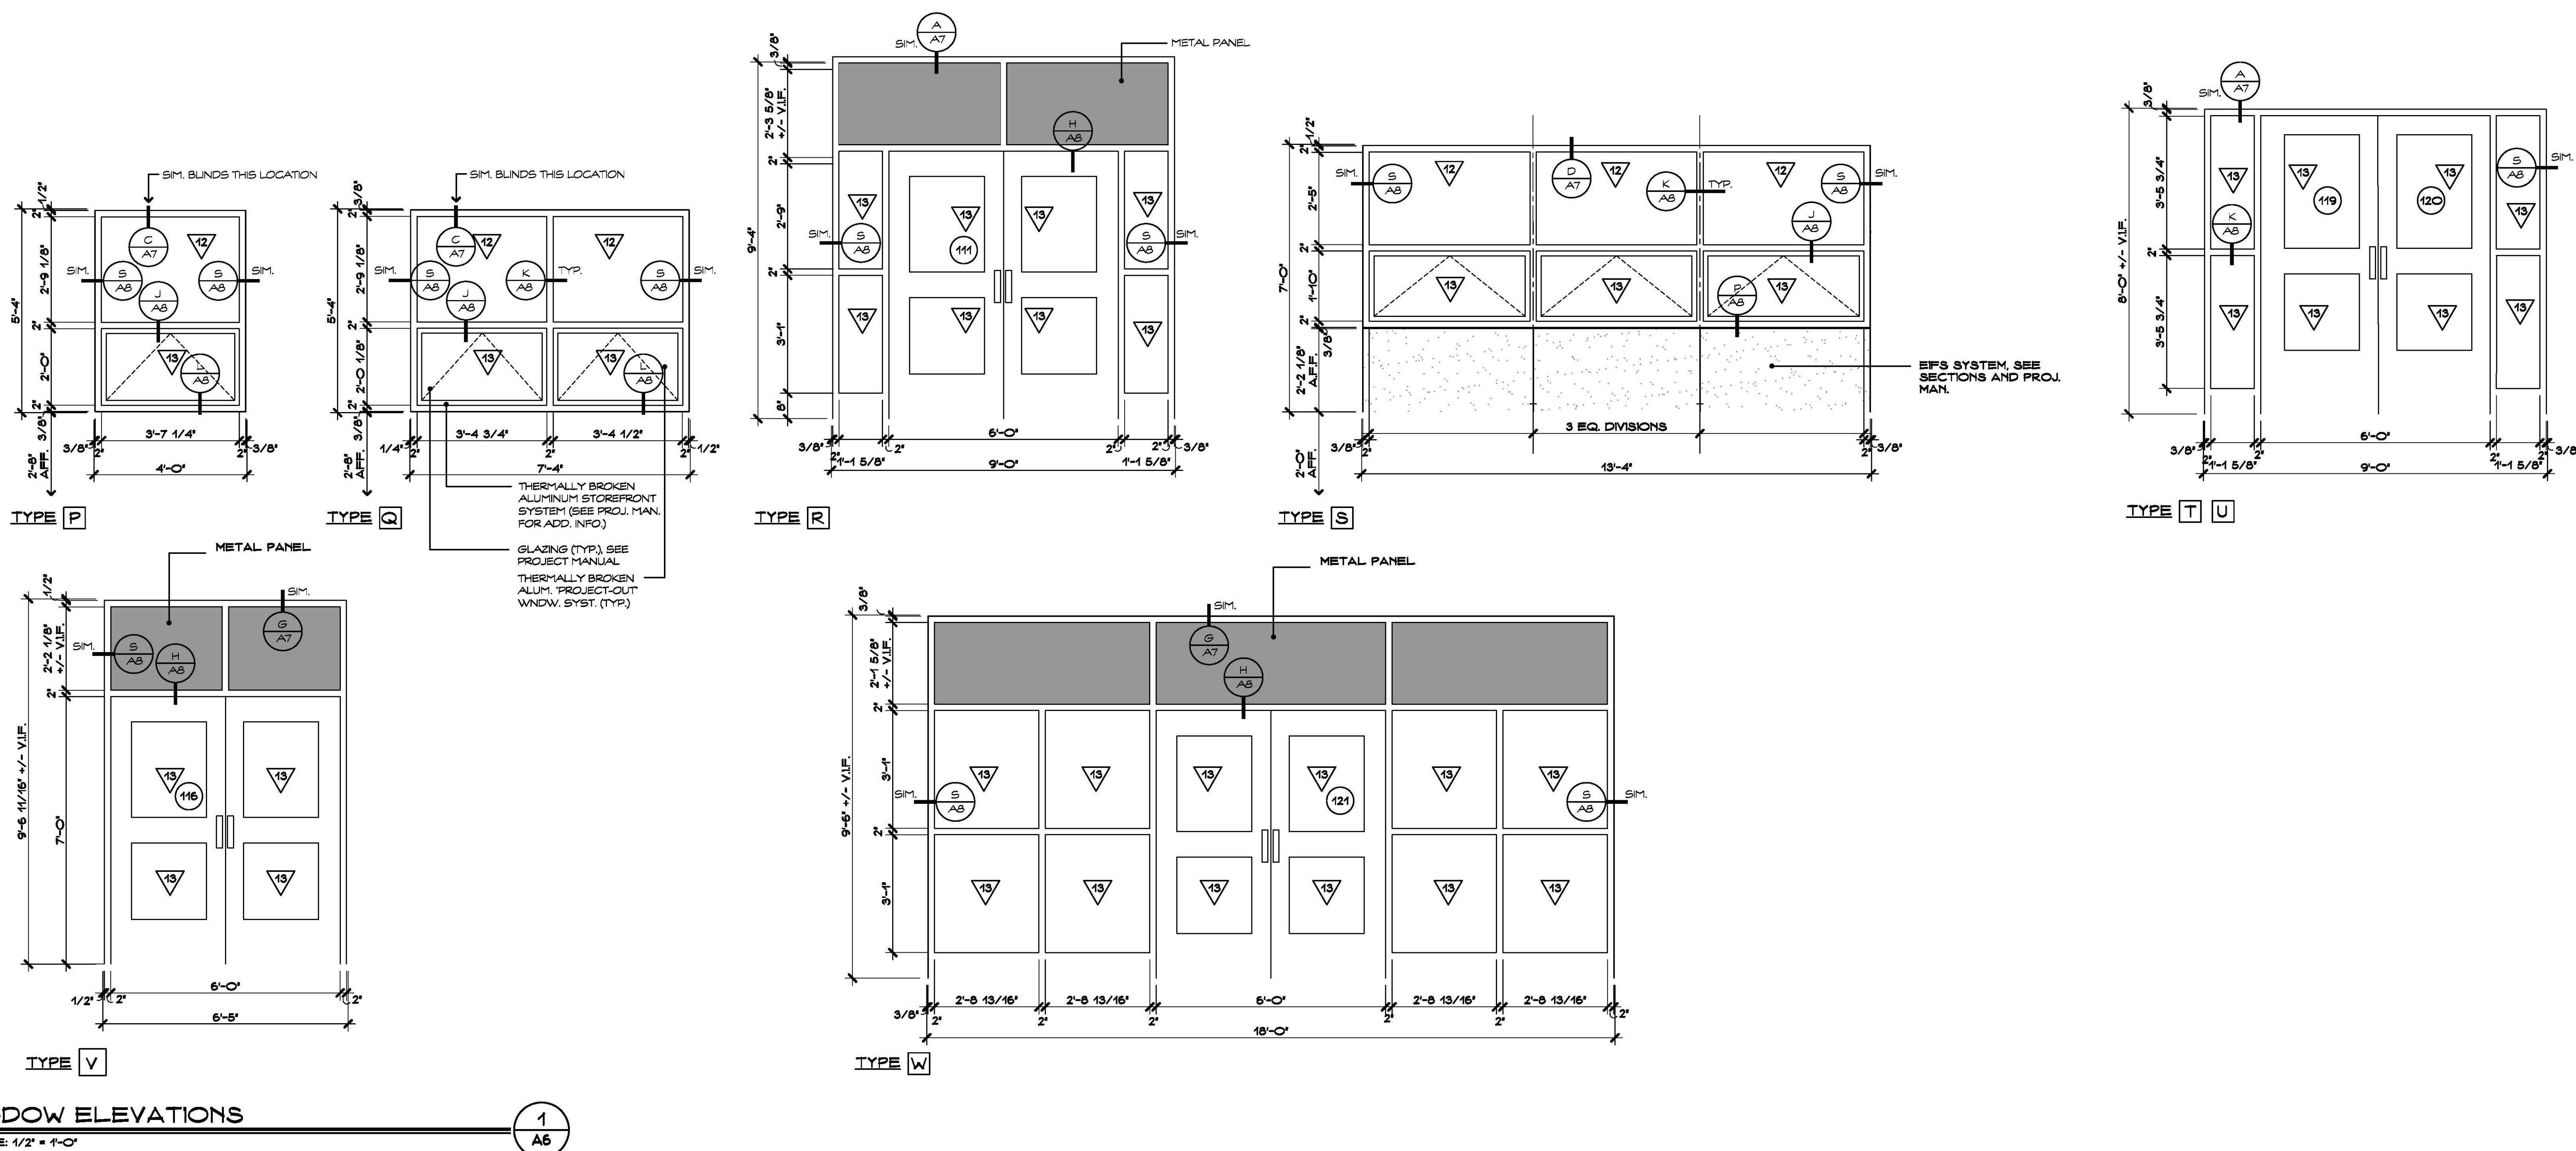


PROVIDE CLASSROOM NUMBER DECAL AT ALL CLASSROOMS HAVING EXTERIOR WINDOWS. PLACE DECALS (2 PER CLASSROOM) IN THE UPPER RIGHT HAND CORNER OF THE UPPERCASE WINDOWS (UPPER 1/3 OF THE SIDE OF THE UPPERCASE WINDOW). INSTALLATION SHALL BE IN COMPLIANCE WITH ADA STANDARDS AND OTHER APPLICABLE REGULATIONS AS REQUIRED. TYPICAL FOR ALL STOREFRONT AND CURTAIN WALL ASSEMBLIES. REFER TO CLASSROOM DECAL.




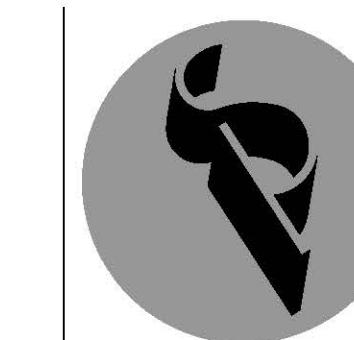


HEAD DETAIL  
SCALE 3'-0"

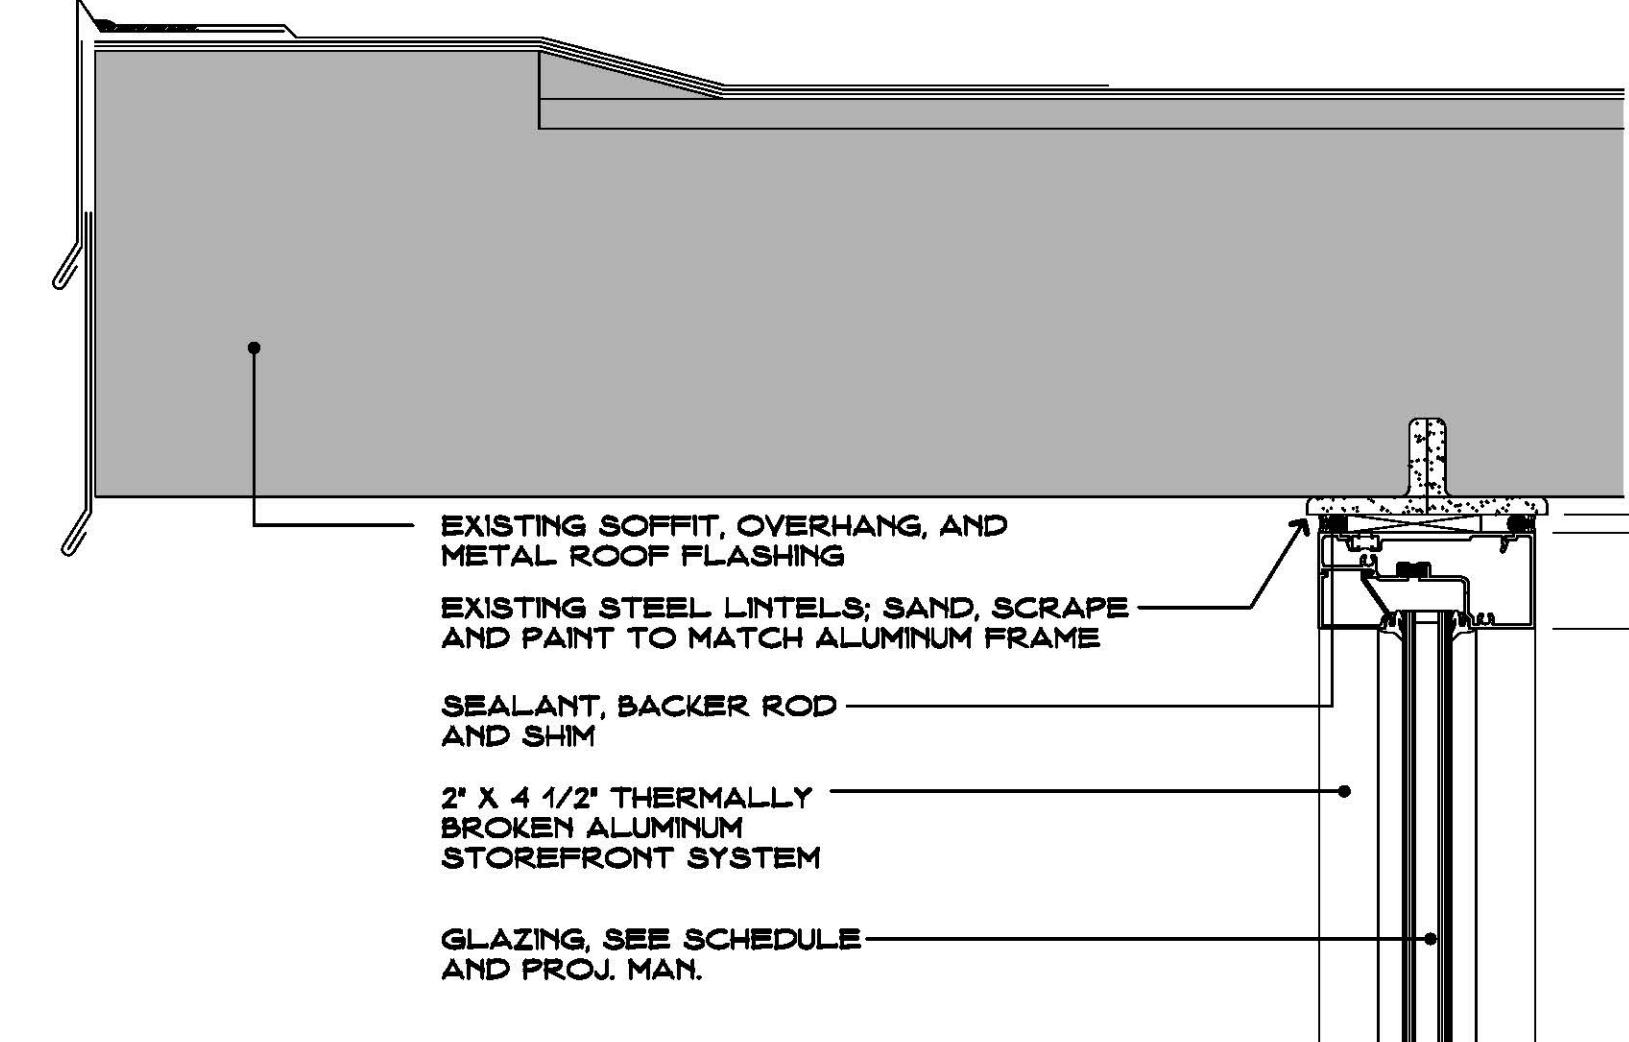


HEAD DETAIL  
SCALE 3'-0"

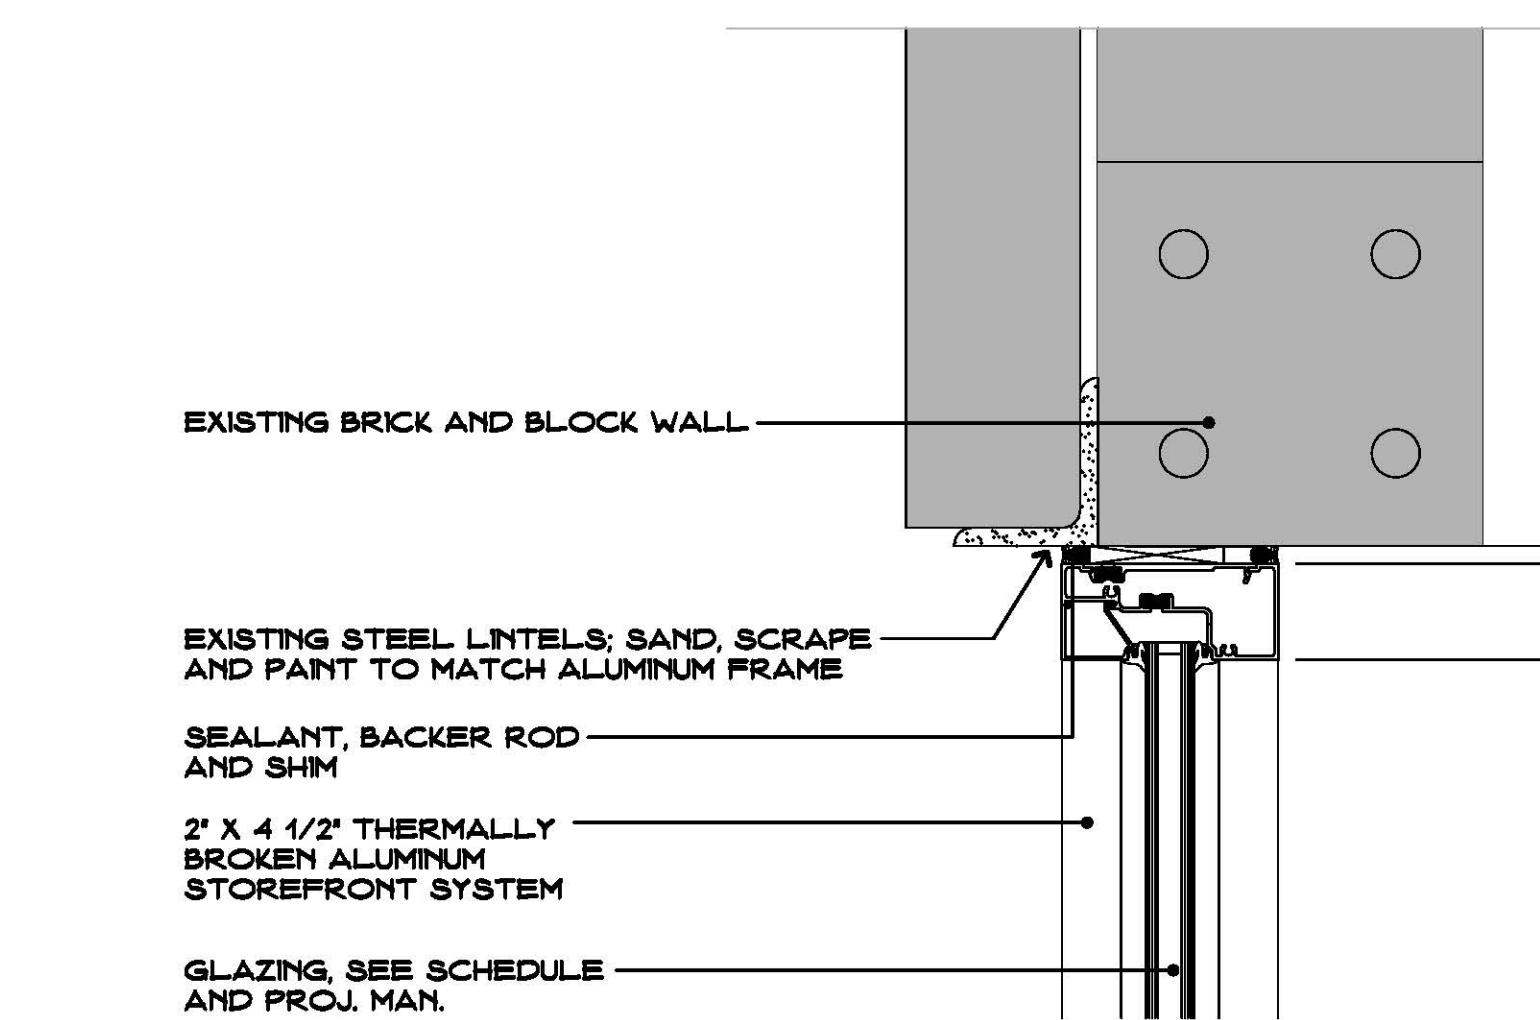


HEAD DETAIL  
SCALE 3'-0"

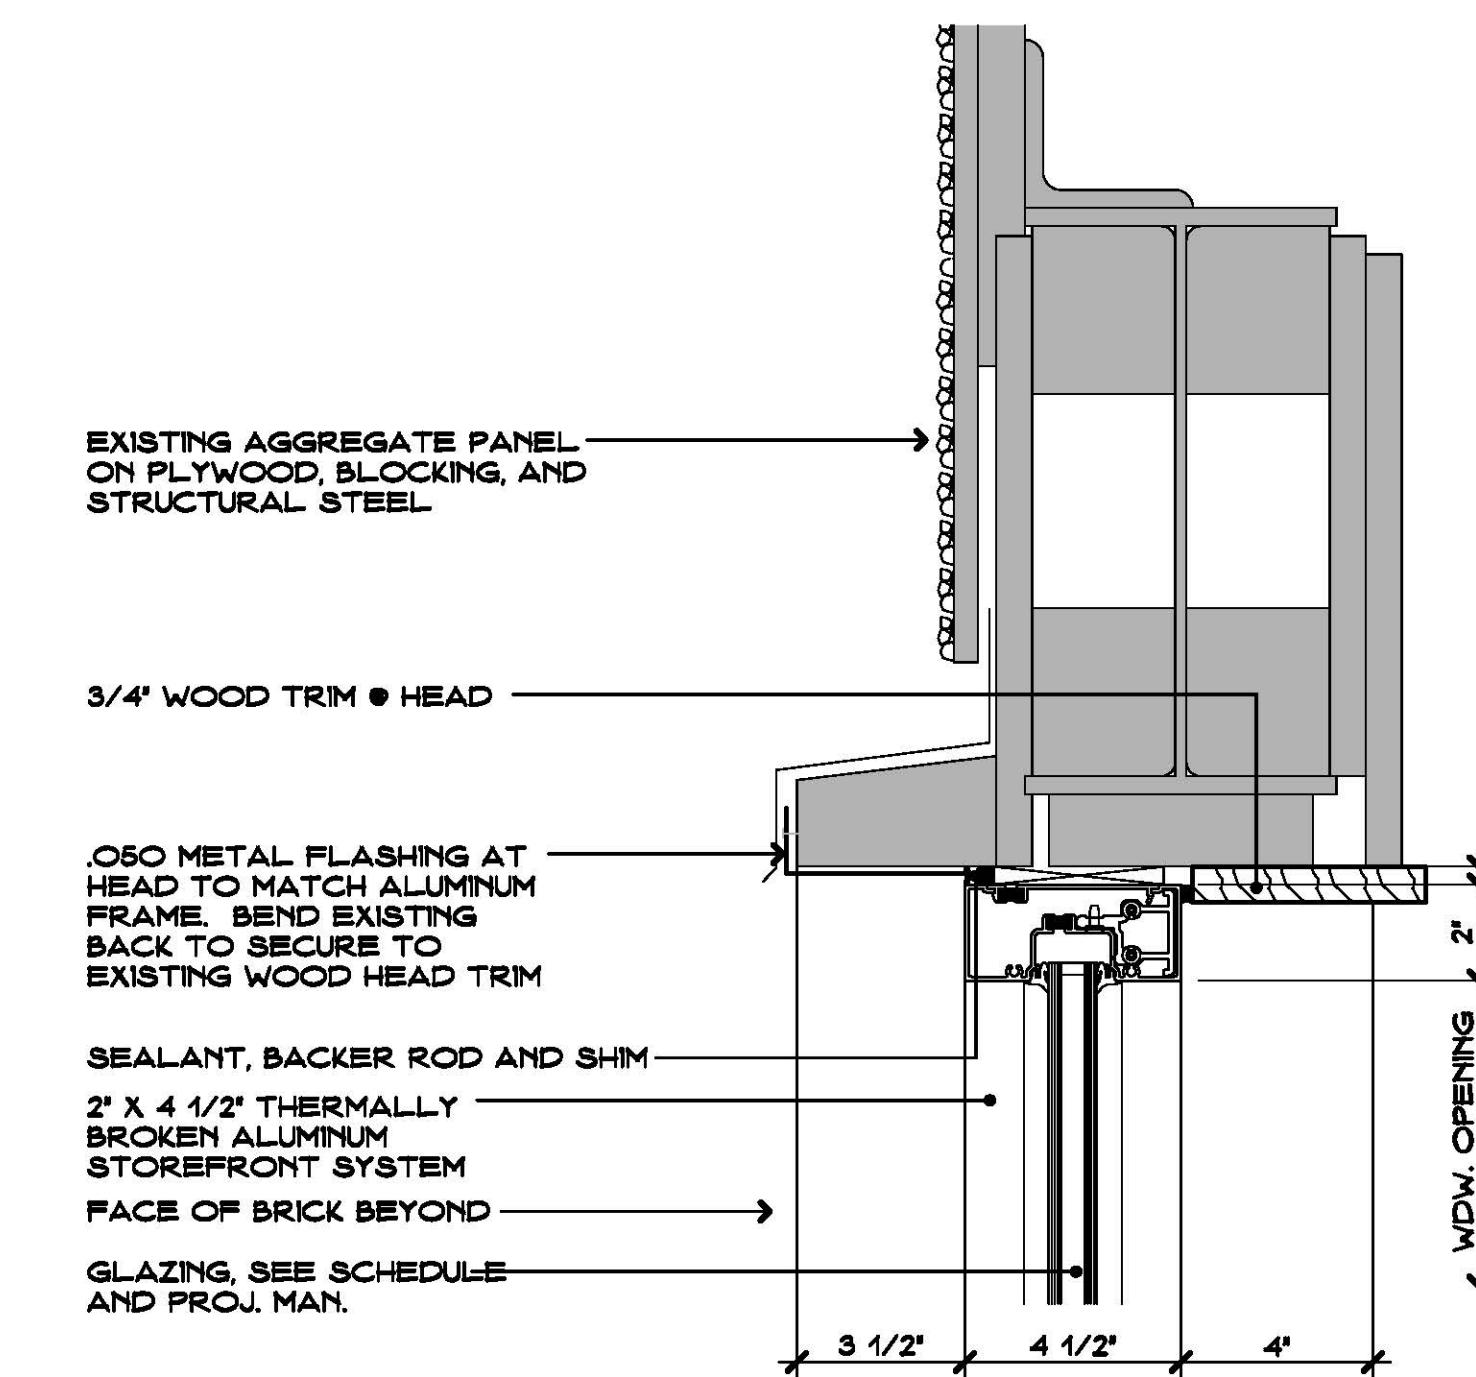


HEAD DETAIL  
SCALE 3'-0"

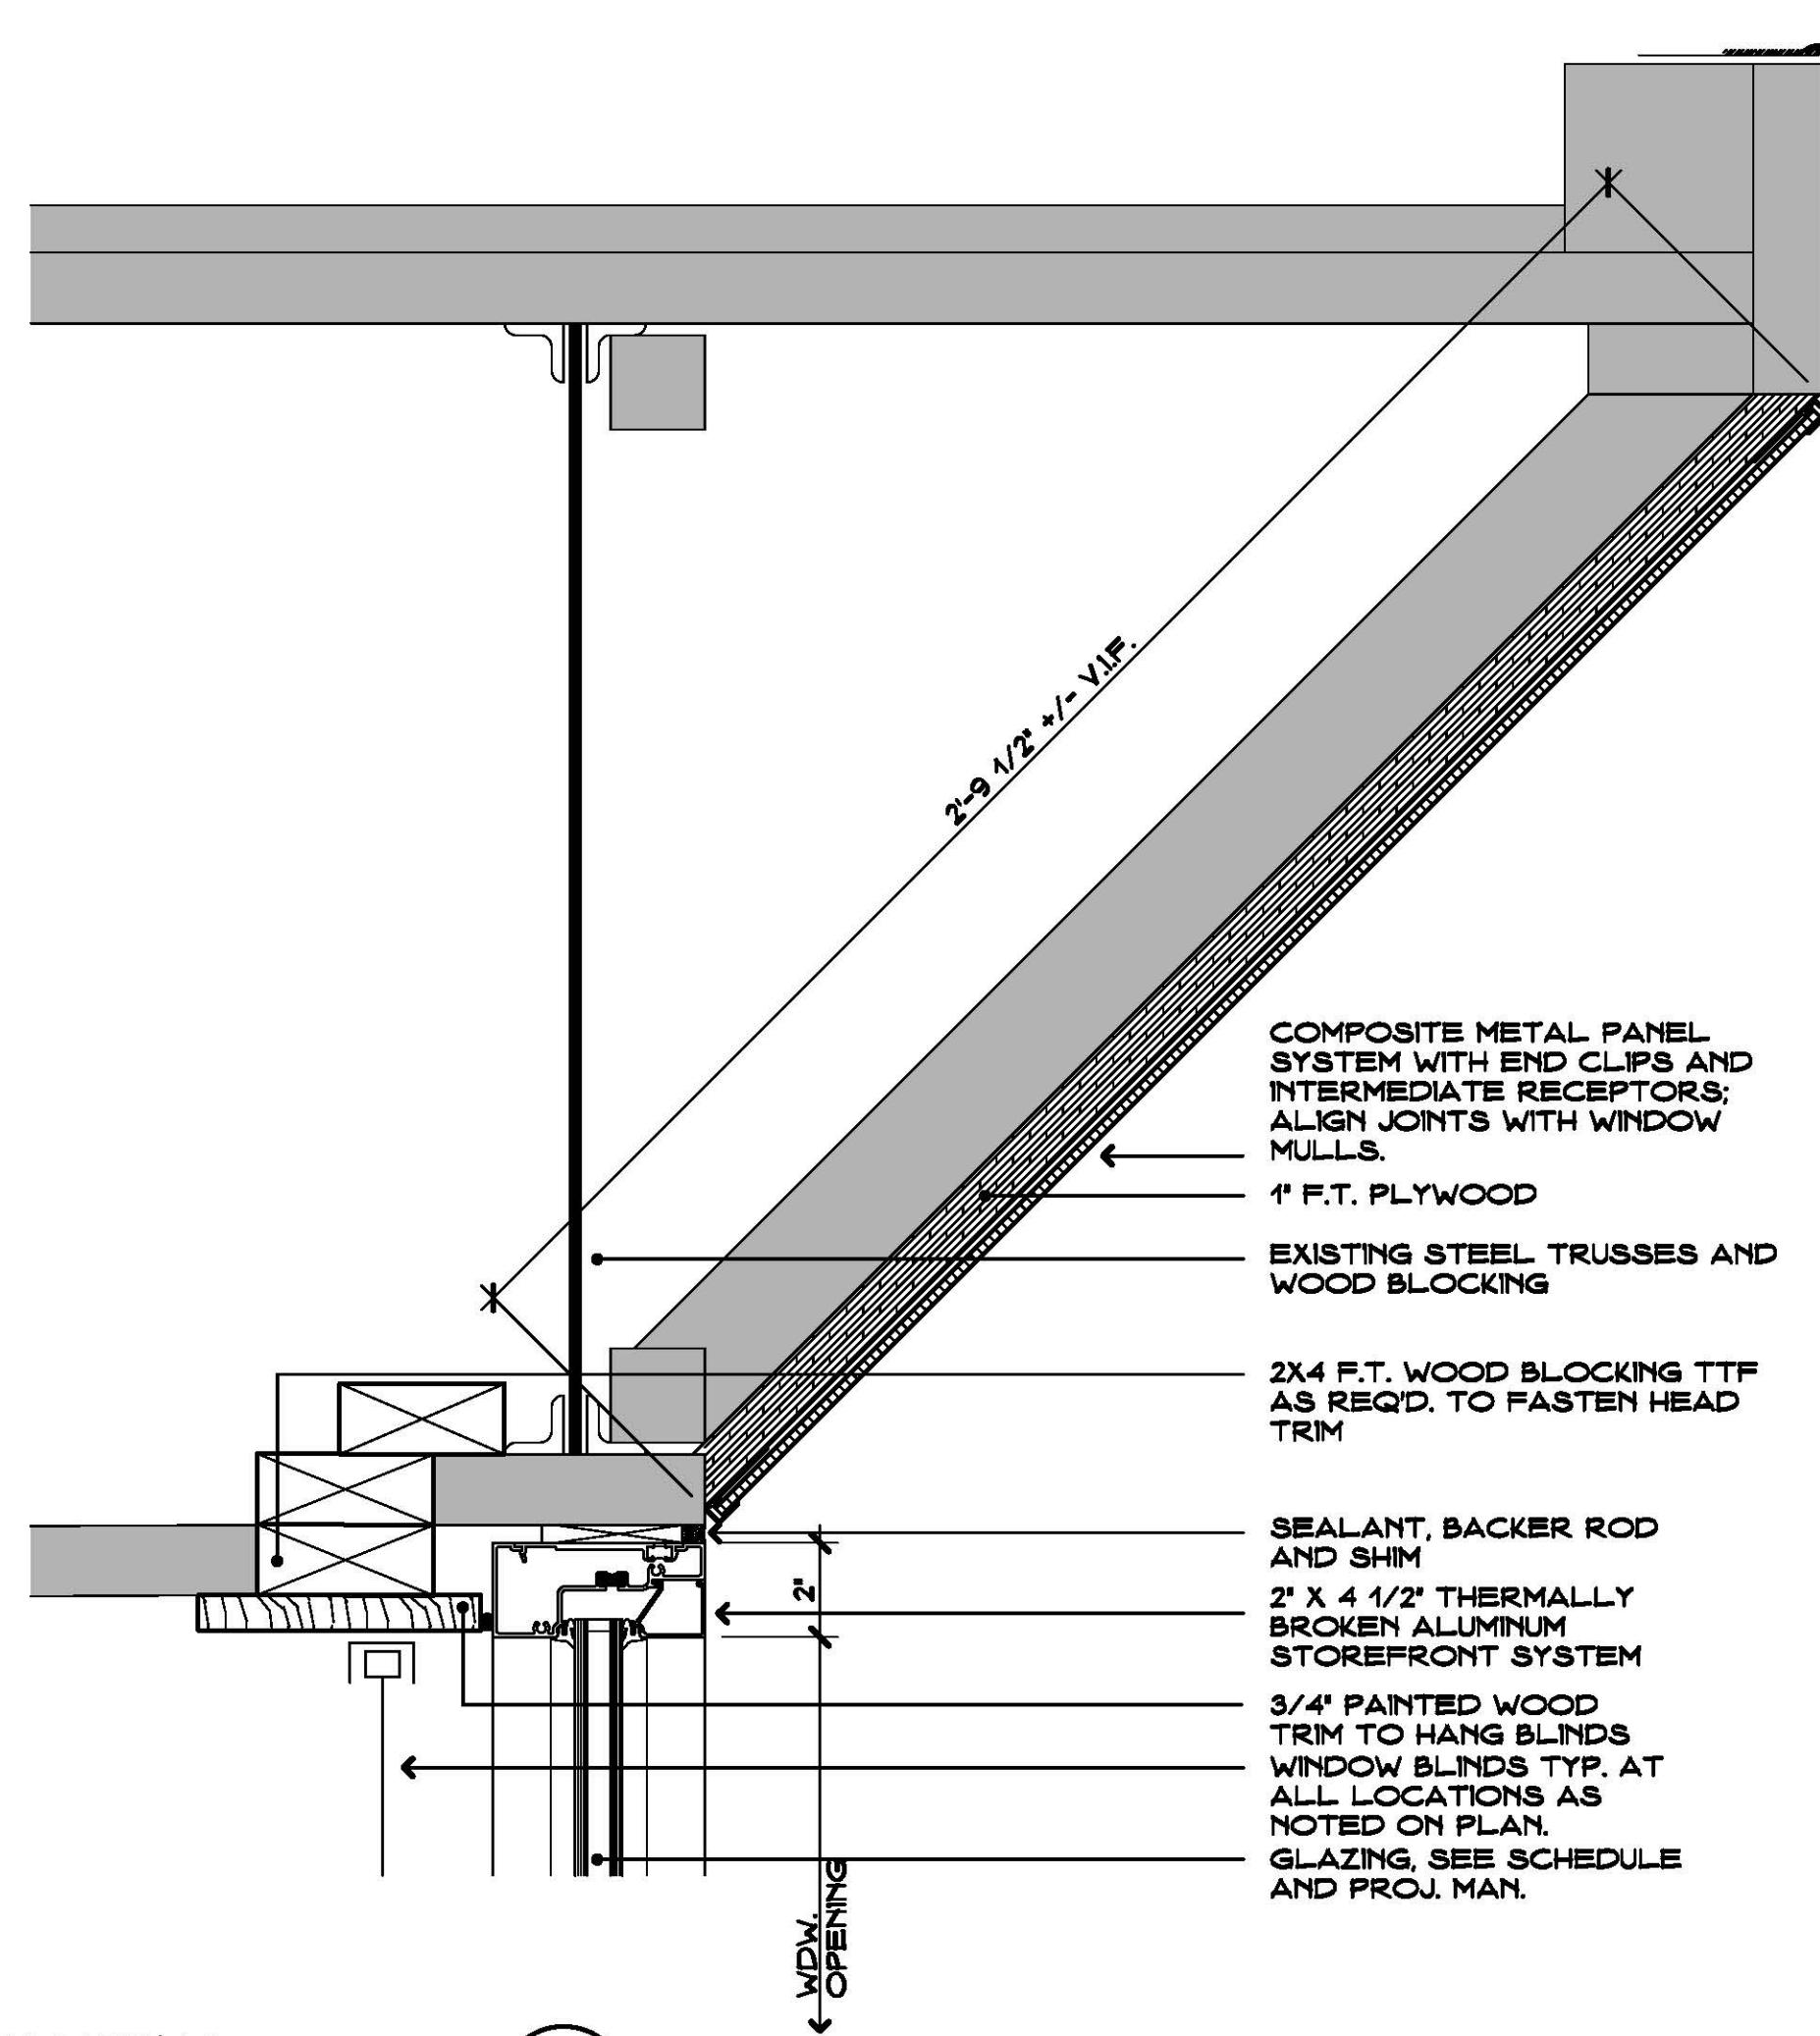

HEAD DETAIL  
SCALE 3'-0"

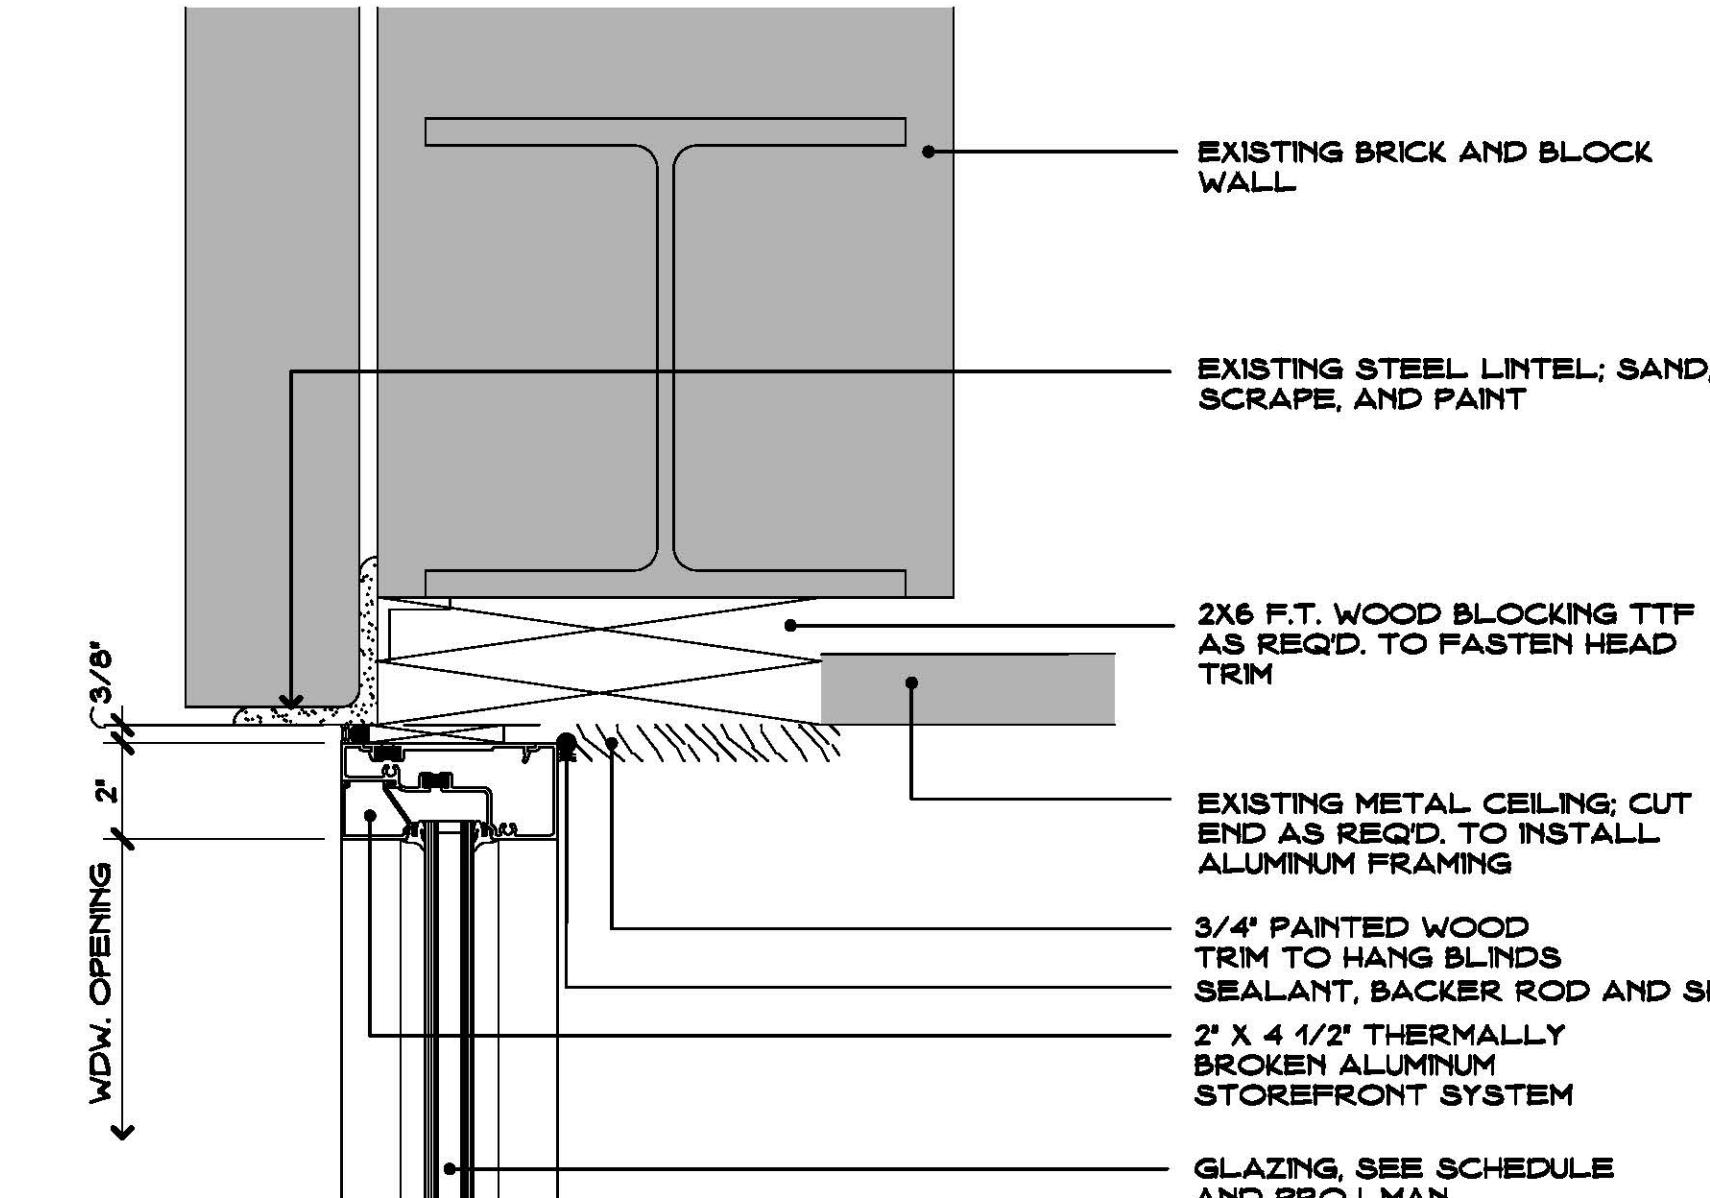

HEAD DETAIL  
SCALE 3'-0"

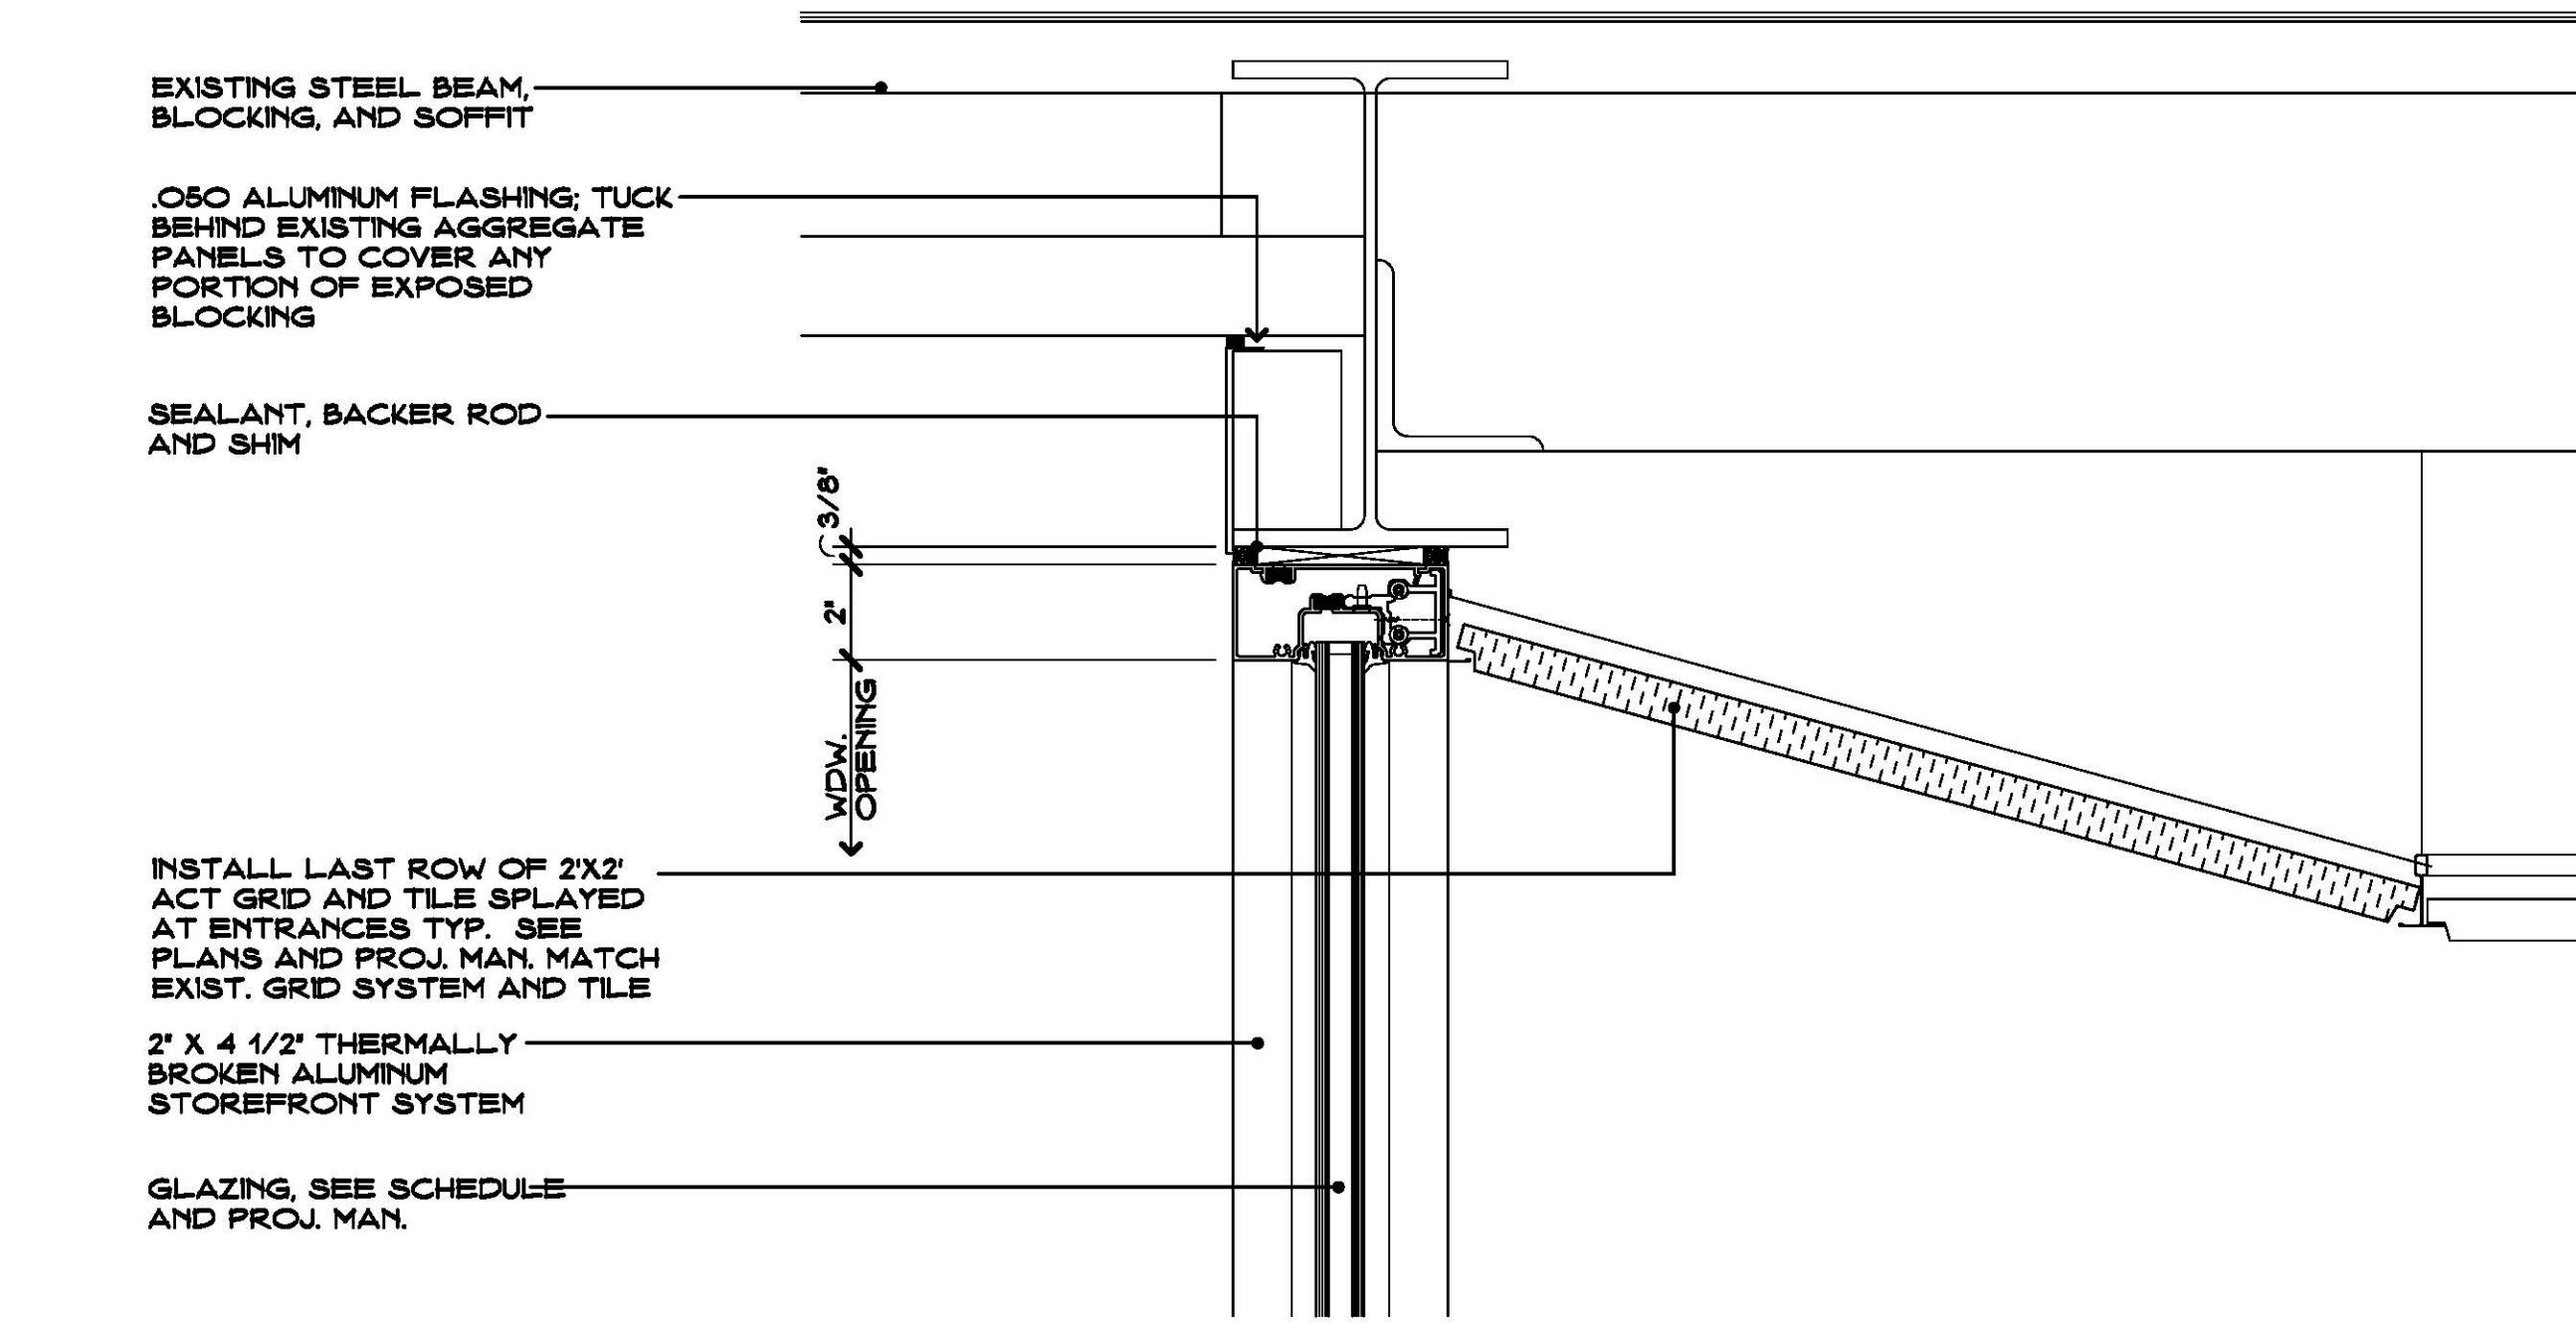


HEAD DETAIL  
SCALE 3'-0"

## WINDOW DETAILS

SCALE: 3'-0"

1  
A7

Project Title: Window Replacement and Entrances:  
Booth Hill Elementary School  
544 Booth Hill Road  
Trumbull, Connecticut 06484

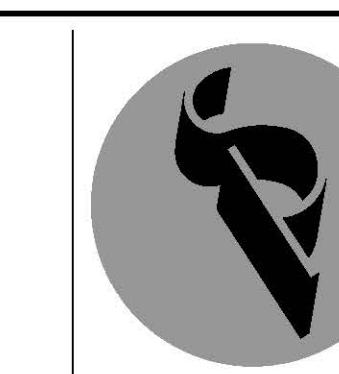


SILVER / PETRUCCIELLI + ASSOCIATES  
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silverpetrucciello.com

Revision: \_\_\_\_\_  
Description: \_\_\_\_\_  
Date: \_\_\_\_\_  
Revised By: \_\_\_\_\_

Drawing Title: Window Details  
STATE PROJECT #144-0105 EC/CV  
Drawing Number: A7


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Drawn By: AS NOTED  
Drawn By: CON  
Project Number: 18.089

A7

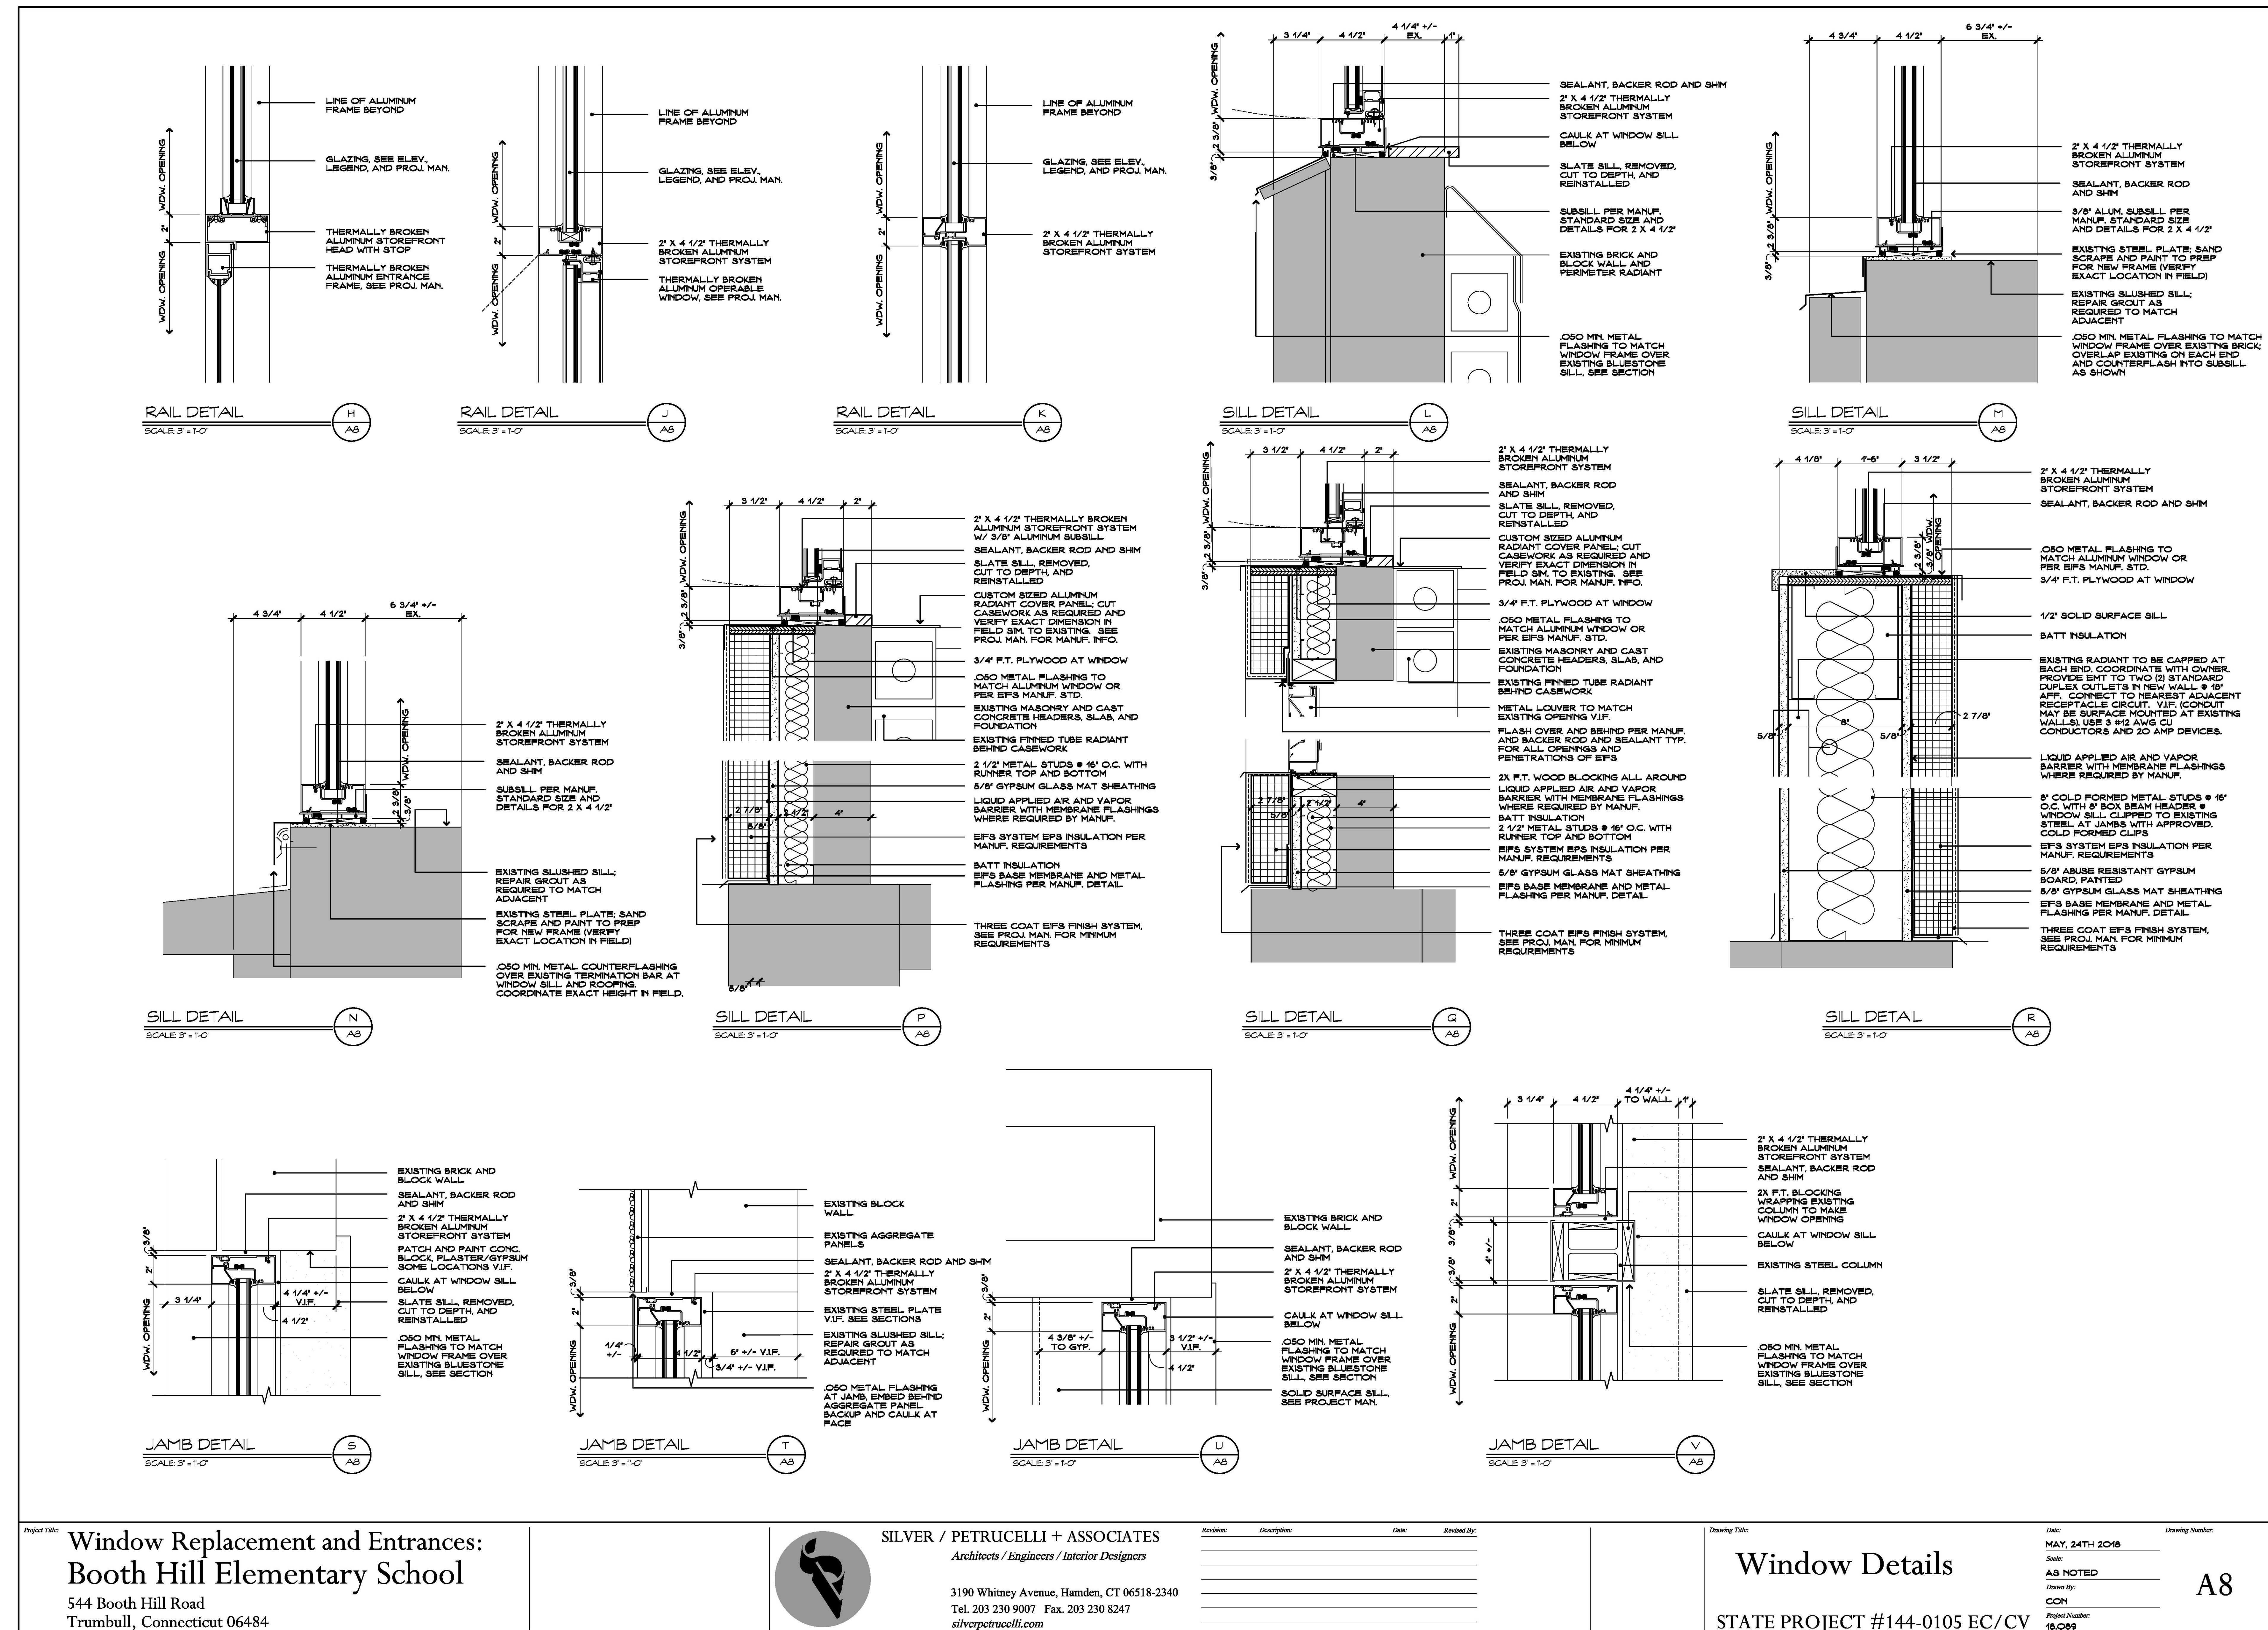


## DOOR SCHEDULE

DOOR NUMBER	DOOR			FRAME			FIRE	HARDWARE - SEE PROJECT MANUAL						REMARKS							
	SIZE	DOUBLE LEAF	WIDTH	HEIGHT	TYPE - SEE 2/ASCO	MATERIAL		TYPE	WIDTH	HEIGHT	MATERIAL	HEAD DETAIL	JAMB DETAIL	SADDLE DETAIL	GLAZING	SMOKE RESISTANT	RATING	CODE	DISABLED REQ.	IDENTIFICATION	
100	3'-0"	6'-8"	1	HM	EX	EX	HM	EX	EX	A						1 HR.	1 HR.				
101	3'-0"	6'-8"	1	HM	EX	EX	HM	EX	EX	A						1 1/2 HR.	2 HR.				
102	3'-0"	6'-8"	1	HM	EX	EX	HM	EX	EX	A											
103	3'-0"	6'-8"	1	HM	EX	EX	HM	EX	EX	A											
104	3'-0"	6'-8"	1	HM	EX	EX	HM	EX	EX	A											
105	3'-0"	6'-8"	1	HM	EX	EX	HM	EX	EX	A											
106	3'-0"	6'-8"	1	HM	EX	EX	HM	EX	EX	A											
107	• 3'-0"	6'-8"	3	HM	GL-13	EX	EX	HM	EX	EX	A										
108	• 3'-0"	7'-0"	4	AL	GL-13	SEE WDW.	ELEV.	AL	SEE ELEV.	A	•										
109	• 3'-0"	7'-0"	4	AL	GL-17	SEE WDW.	ELEV.	AL	SEE ELEV.	A	•										
110	• 3'-0"	7'-0"	4	AL	GL-17	SEE WDW.	ELEV.	AL	SEE ELEV.	A	•										
111	• 3'-0"	7'-0"	4	AL	GL-17	SEE WDW.	ELEV.	AL	SEE ELEV.	A	•										
112	• 3'-0"	7'-0"	4	AL	GL-17	SEE WDW.	ELEV.	AL	SEE ELEV.	A	•										
113	3'-0"	6'-8"	1	HM	EX	EX	HM	EX	EX	A											
114	3'-0"	6'-8"	1	HM	EX	EX	HM	EX	EX	A											
115	3'-0"	6'-8"	1	HM	EX	EX	HM	EX	EX	A											
116	• 3'-0"	7'-0"	4	AL	GL-13	SEE WDW.	ELEV.	AL	SEE ELEV.	A	•										
117	• 3'-0"	7'-0"	4	AL	GL-13	SEE WDW.	ELEV.	AL	SEE ELEV.	A	•										
118	• 3'-0"	6'-8"	1	HM	EX	EX	HM	EX	EX	A											
119	• 3'-0"	7'-0"	4	AL	GL-13	SEE WDW.	ELEV.	AL	SEE ELEV.	A	•										
120	• 3'-0"	7'-0"	4	AL	GL-13	SEE WDW.	ELEV.	AL	SEE ELEV.	A	•										
121	3'-0"	7'-0"	4	AL	GL-13	SEE WDW.	ELEV.	AL	SEE ELEV.	A	•										
122	• 3'-0"	7'-0"	4	AL	GL-13	SEE WDW.	ELEV.	AL	SEE ELEV.	A	•										
123	3'-0"	6'-8"	1	HM	EX	EX	HM	EX	EX	A											
124	3'-0"	6'-8"	1	HM	EX	EX	HM	EX	EX	A											
125	3'-0"	6'-8"	2	HM	GL-13	EX	EX	HM	EX	EX	A										
<b>LEGEND</b>																					
<b>NOTES</b>																					
EX EXISTING AL ALUMINUM INSUL. INSULATED																					
1. NEW DOOR IN EXISTING FRAME. SAND, FILL WITH BONDING MATERIAL. 2. ALL DOORS TO RECEIVE AN EXTERIOR DOOR NUMBERING DECAL ON THE INTERIOR TO MATCH EXISTING. 3. CLASSROOM DOORS EXITING DIRECTLY TO THE EXTERIOR SHALL HAVE NO HARDWARE ON EXTERIOR U.O.N. ON SCHEDULE. 4. INSTALL NEW THRESHOLDS ON EXISTING FRAMES TO REMAIN.																					
5. EXISTING AIPHONE SYSTEM TO BE RECONNECTED TO NEW ENTRANCE PATCH, AND PAINT EXISTING FRAMES. VERIFY DOOR WIDTHS IN FIELD. 6. AIPHONE TO BE ADDED FOR ACCESSIBLE ENTRANCE, TO MATCH EXISTING SYSTEM. 7. PATCH, PREP & PAINT INTERIOR WALL FINISHES 24' FROM PERIMETER. 8. RELOCATE EXISTING EXTERIOR DOOR SIGN TO WALL. 9. ALL GLAZING TO BE INSULATED.																					
<b>GLAZING LEGEND</b>																					
GL-12 INSULATED, TINTED GL-13 INSULATED, TINTED, TEMPERED GL-15 INSULATED, TINTED, FROSTED																					
GL-17 INSULATED, TINTED, LAMINATED GL-21 INSULATED, TINTED, SPANDREL, LAMINATED																					
<b>GENERAL NOTES</b>																					
1. ALL GLAZING TO BE INSULATED.																					

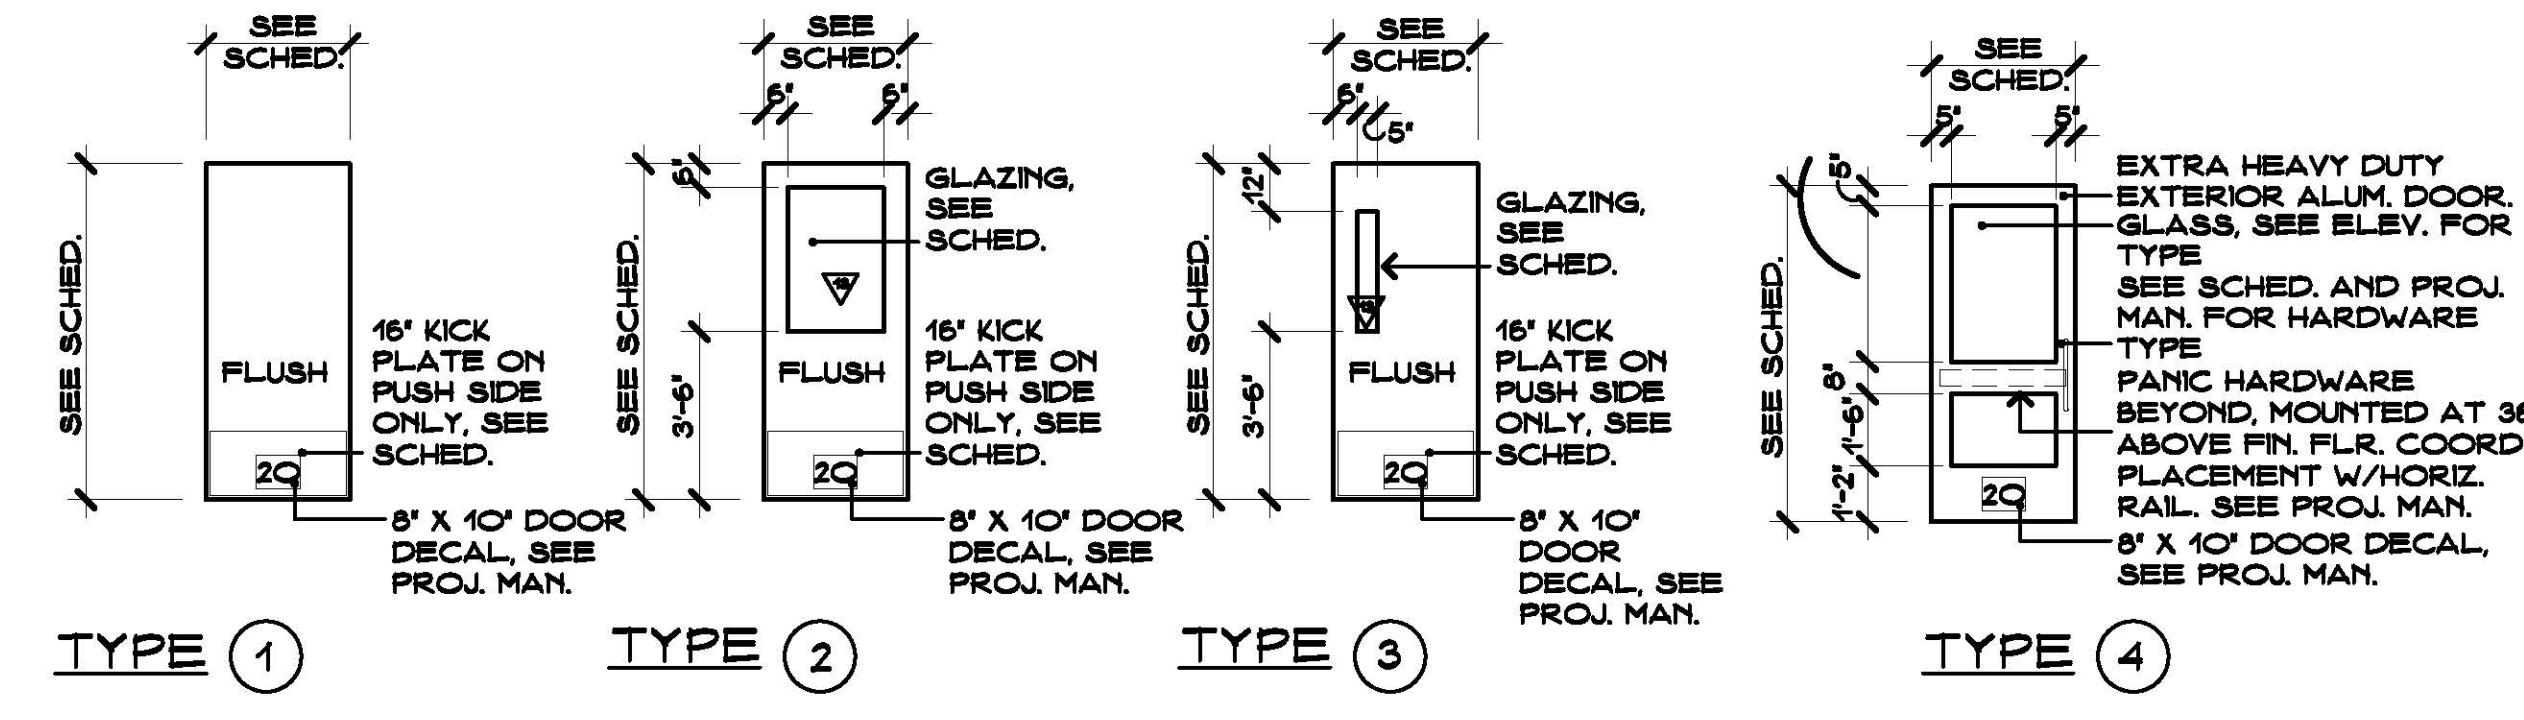

## DOOR ELEVATIONS

SCALE: 1/2" = 1'-0"

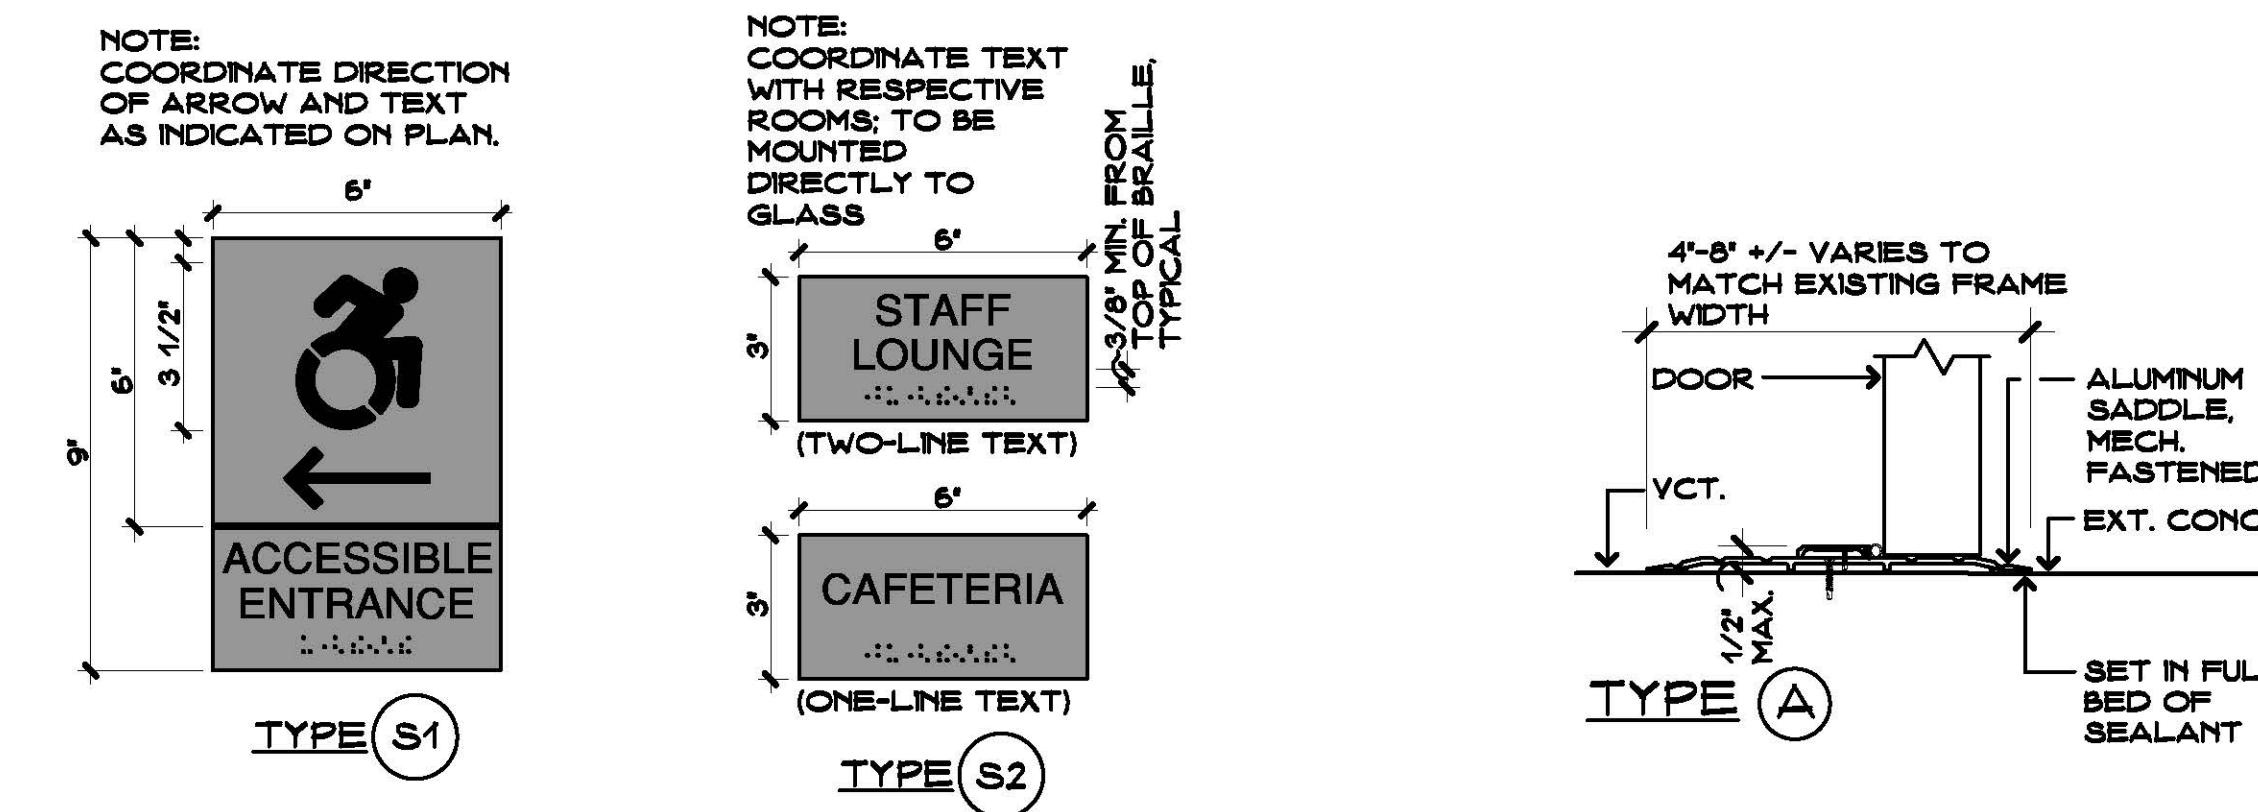

## SIGN DETAIL

SCALE: 3' = 1'-0"

SCALE: 3' = 1'-0"

A9

A9

2

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A9

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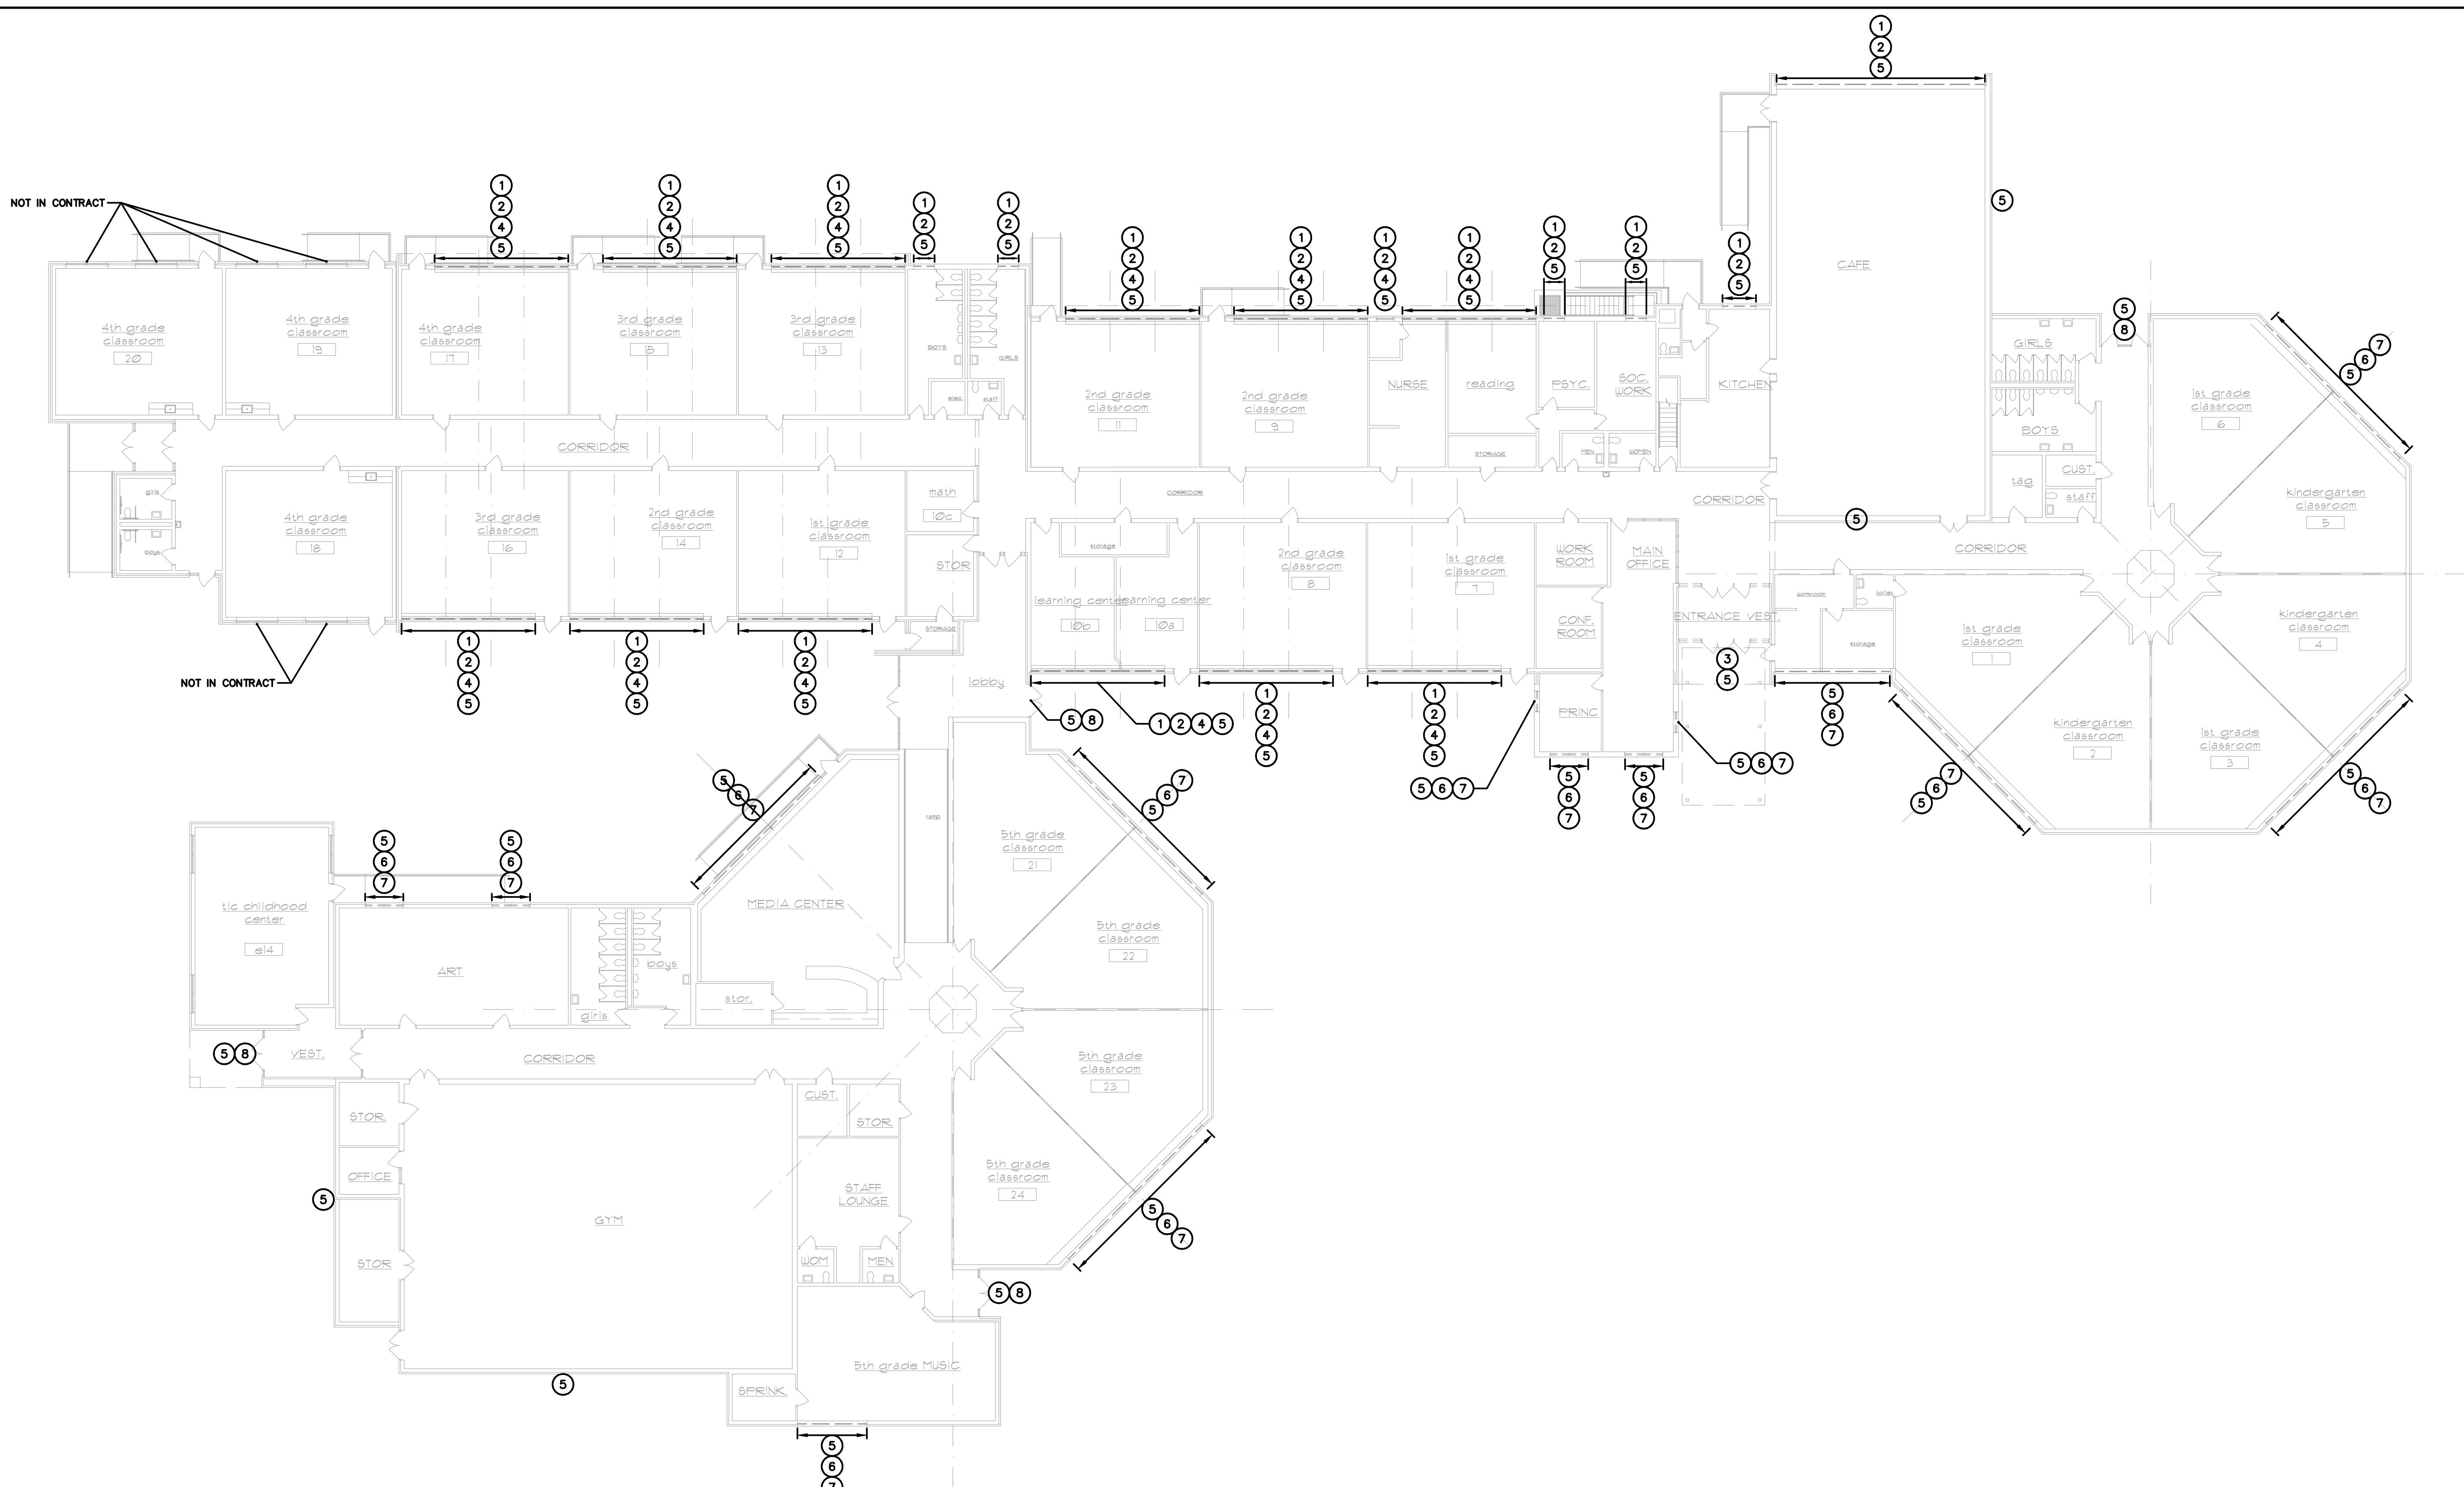
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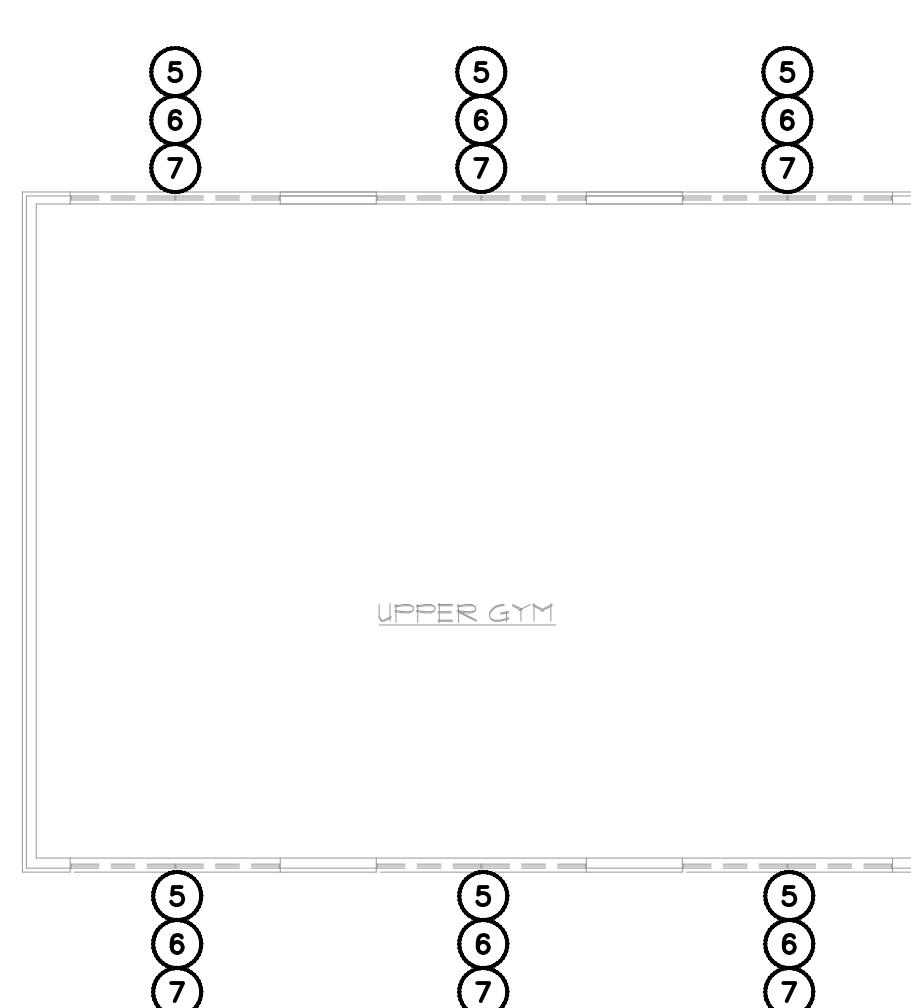
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A9



main level abatement plan

SCALE: 1/16" = 1'-0"



1  
A1



upper gym abatement plan

SCALE: 1/16" = 1'-0"

2  
A2



upper cafe abatement plan

SCALE: 1/16" = 1'-0"

3  
A2



#### ASBESTOS AND PRESUMED PCB BULK PRODUCT ABATEMENT NOTES

- ① THE HAZARDOUS MATERIALS ABATEMENT CONTRACTOR SHALL REMOVE AND DISPOSE OF WINDOW CAULKING COMPOUND AS ACM AND PRESUMED PCB BULK PRODUCT.
- ② THE HAZARDOUS MATERIALS ABATEMENT CONTRACTOR SHALL REMOVE AND DISPOSE OF WINDOW GLAZING COMPOUND AS CONTAINING TRACE ASBESTOS AND PRESUMED PCB BULK PRODUCT MIXED WASTE.
- ③ THE HAZARDOUS MATERIALS ABATEMENT CONTRACTOR SHALL REMOVE AND DISPOSE OF WINDOW/DOOR SYSTEM CAULKING COMPOUND AS ACM AND PRESUMED PCB BULK PRODUCT MIXED WASTE.
- ④ THE HAZARDOUS MATERIALS ABATEMENT CONTRACTOR SHALL REMOVE AND DISPOSE OF CEMENT BOARD (TRANSITE) SOFFIT AS ACM.
- ⑤ THE HAZARDOUS MATERIALS ABATEMENT CONTRACTOR SHALL REMOVE AND DISPOSE OF DAMP PROOFING BEHIND BRICK AS ACM.
- ⑥ THE HAZARDOUS MATERIALS ABATEMENT CONTRACTOR SHALL REMOVE AND DISPOSE OF WINDOW CAULKING COMPOUND AS PRESUMED PCB BULK PRODUCT.
- ⑦ THE HAZARDOUS MATERIALS ABATEMENT CONTRACTOR SHALL REMOVE AND DISPOSE OF WINDOW GLAZING COMPOUND AS PRESUMED PCB BULK PRODUCT.
- ⑧ THE HAZARDOUS MATERIALS ABATEMENT CONTRACTOR SHALL REMOVE AND DISPOSE OF WINDOW/DOOR SYSTEM CAULKING COMPOUND AS PRESUMED PCB BULK PRODUCT.

#### GENERAL NOTES

1. THE HAZARDOUS MATERIALS ABATEMENT CONTRACTOR SHALL BE RESPONSIBLE FOR THE VERIFICATION OF ALL EXISTING CONDITION AND QUANTITIES, AND FOR NOTIFYING THE CONSULTANT OF ANY DISCREPANCIES PRIOR TO FINALIZING BID.
2. RENOVATION AREAS REPRESENTED ON THIS DRAWING ARE TO BETTER AID IN THE IDENTIFICATION OF AREAS REQUIRING ABATEMENT. THE CONTRACTOR SHALL REFER TO ARCHITECTURAL DRAWINGS FOR RENOVATION INFORMATION.
3. THE CONTRACTOR IS RESPONSIBLE FOR PROVIDING TEMPORARY WATER, POWER, HEAT, LIFTS, STAGING, ETC. AS NEEDED AT THE SITE. TEMPORARY LIGHTING WITHIN THE WORK AREAS MUST BE CONNECTED TO GROUND FAULT CIRCUIT INTERRUPTER (GFCI) POWER PANELS INSTALLED BY A STATE OF CONNECTICUT LICENSED ELECTRICIAN, PERMITTED AS REQUIRED, AND LOCATED OUTSIDE THE WORK AREAS.